
PRELIMINARY & FINAL MAJOR SITE PLAN FOR

TAX BLOCK 72.01 - LOT 10.01

TOWNSHIP OF MANCHESTER

OCEAN COUNTY

NEW JERSEY

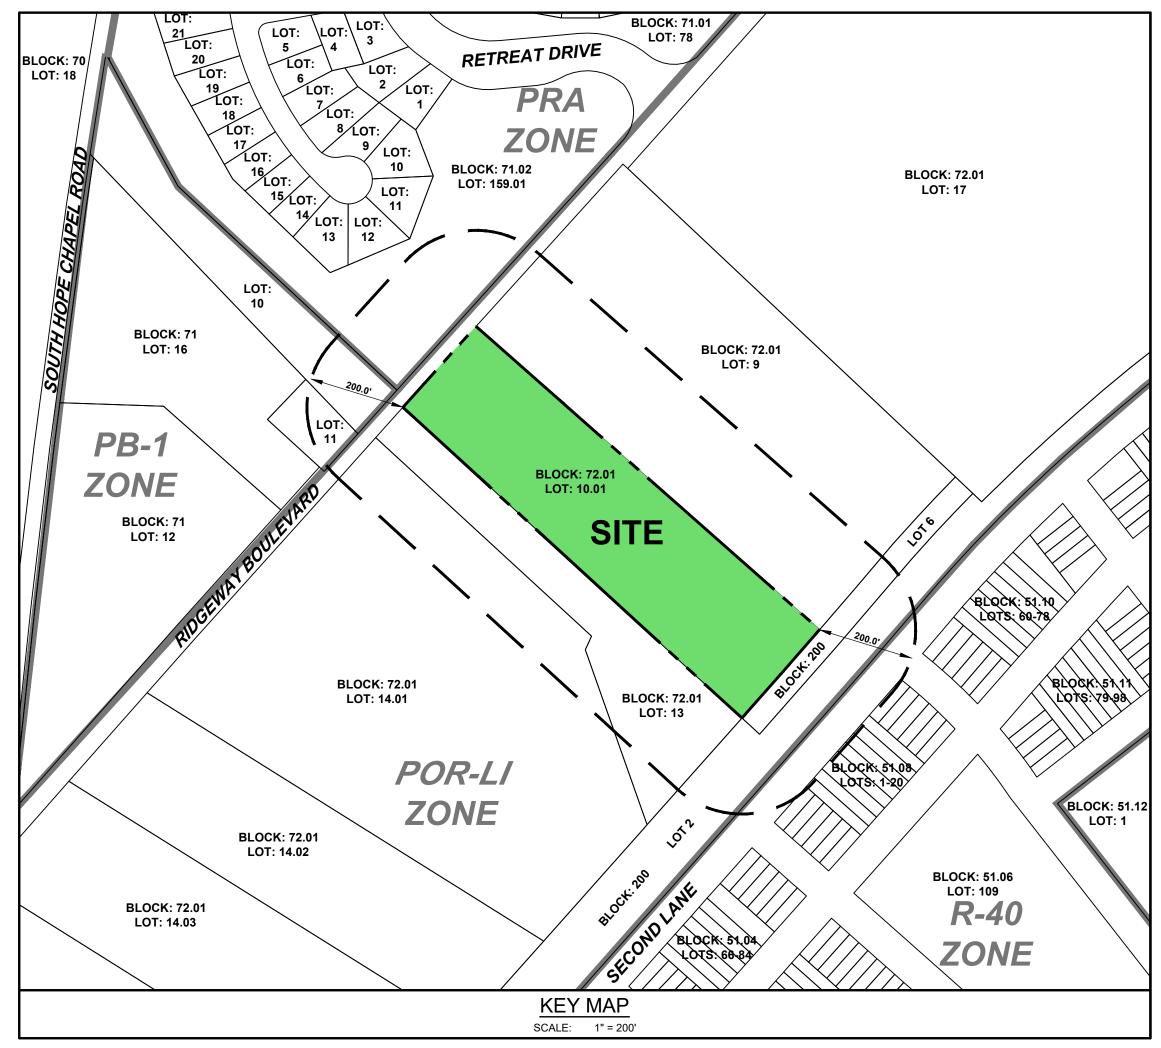

	SHEET INDEX
Sheet No.	Description
1	COVER SHEET
2	DEMOLITION PLAN
3	SITE PLAN
4	GRADING PLAN
5	STORM DRAINAGE PLAN
6	UTILITY PLAN
7	TRAFFIC SIGNAGE & STRIPING PLAN
8	LIGHTING PLAN
9	LANDSCAPE PLAN
10	LANDSCAPE DETAILS
11	CONSTRUCTION DETAILS - SITE
12	CONSTRUCTION DETAILS - STORMWATER
13	CONSTRUCTION DETAILS - UTILITY
14	STORMWATER MAINTENANCE PLAN
15	DRAINAGE AREA MAP

No. of Sheets | Description LAND USE ZONE

SUPPLEMENTAL DRAWINGS

PB-1 PINELANDS BUSINESS POR-LI PINELANDS OFFICE, RESEARCH & LIGHT INDUSTRIAL PRA PINELANDS RURAL AGRICULTURE - 1 R-40 RESIDENTIAL - 40,000 SF

GENERAL NOTES


- 1. PROPERTY IS KNOWN AS BLOCK 72.01 LOT 10.01 AS SHOWN ON THE MANCHESTER
- 2. OUTBOUND & TOPOGRAPHIC INFORMATION TAKEN FROM A MAP ENTITLED TOPOGRAPHIC SURVEY FOR TAX BLOCK 72.01 TAX LOT 10.01 TOWNSHIP OF MANCHESTER, OCEAN COUNTY, NEW JERSEY," AS PREPARED BY PROFESSIONAL DESIGN SERVICES, LLC, DATED JULY 21, 2023.
- 3. THE PROPERTY IS CURRENTLY LOCATED WITHIN THE PB ZONE AND CONTAINS APPROXIMATELY 5.17 ACRES.
- 4. IT IS ASSUMED THAT THERE ARE NO FRESHWATER WETLANDS LOCATED ON OR WITHIN 300 FEET OF THE PROPERTY.
- IT IS PROPOSED TO CONSTRUCT AN OFFICE BUILDING AND CONTRACTOR WAREHOUSE.
- 6. WATER SERVICE WILL BE PROVIDED BY PUBLIC WATER.
- 7. SEWAGE SERVICE WILL BE PROVIDED PUBLIC SEWER.
- 8. ALL UTILITIES (ELECTRIC, TELEPHONE, ETC.) TO BE PROVIDED UNDERGROUND. THE CONTRACTOR MUST VERIFY LOCATION AND DEPTH OF ALL UTILITIES PRIOR TO
- 9. THE SIGHT TRIANGLE EASEMENTS ARE SUBJECT TO RESTRICTIONS CONTAINED
- 10. SOLID WASTE IS TO BE PICKED UP BY A PRIVATE GARBAGE HAULER. THE REFUSE AREA SHALL CONTAIN AN AREA FOR THE COLLECTION OF RECYCLABLE MATERIALS.
- 11. MAINTENANCE OF THE STORMWATER SYSTEM SHALL BE THE RESPONSIBILITY OF
- 12. ALL TRAFFIC CONTROL SIGNAGE INCLUDING PAVEMENT MARKINGS WILL BE PROVIDED IN ACCORDANCE WITH THE "MANUAL ON UNIFORM TRAFFIC CONTROL
- 13. ALL DISTURBED AREAS WILL BE VEGETATIVELY STABILIZED IN ACCORDANCE WITH THE CERTIFIED SOIL EROSION AND SEDIMENT CONTROL PLAN UPON COMPLETION OF THE GRADING ACTIVITIES.
- 14. EXISTING CONDITIONS AND DIMENSIONS TO BE VERIFIED BY THE CONTRACTOR PRIOR TO CONSTRUCTION. CONTRACTOR SHALL VERIFY THE LOCATION AND DEPTH
- 15. ALL CONSTRUCTION TO BE IN CONFORMANCE WITH APPLICABLE CODES, ORDINANCES AND MANUFACTURER'S REQUIREMENTS.
- 16. TRAFFIC DIRECTION ARROWS, FIRE LANE MARKINGS, ETC. SHALL BE IN CONFORMANCE WITH MANCHESTER TOWNSHIP FIRE PREVENTION BUREAU AND TOWNSHIP ENGINEERING DEPARTMENT REQUIREMENTS.
- 17. THE OWNER OR HIS/HER REPRESENTATIVE, IS TO DESIGNATE AN INDIVIDUAL RESPONSIBLE FOR CONSTRUCTION SITE SAFETY DURING THE COURSE OF SITE IMPROVEMENTS PURSUANT TO NJAC 5:23-2.21(e) OF THE NJ UNIFORM CONSTRUCTION CODE AND CFR 1926.32(f) (OSHA COMPETENT PERSON). PROFESSIONAL DESIGN SERVICES, LLC ASSUMES NO RESPONSIBILITY FOR CONSTRUCTION SITE SAFETY.
- 18. ALL HANDICAPPED PARKING SPACES SHALL BE CONSTRUCTED TO MEET ADA REQUIREMENTS.
- 19. NO PHASING OF SITE IMPROVEMENTS IS PROPOSED.
- 20. IT IS THE RESPONSIBILITY OF THE CONTRACTOR TO REVIEW ALL OF THE DRAWINGS AND SPECIFICATIONS ASSOCIATED WITH THE PROJECT WORK SCOPE PRIOR TO THE INITIATION OF CONSTRUCTION. SHOULD THE CONTRACTOR FIND A CONFLICT WITH THE DOCUMENTS RELATIVE TO THE SPECIFICATION OR THE RELATIVE CODES, IT IS THE CONTRACTOR'S RESPONSIBILITY TO NOTIFY THE PROJECT ENGINEER OF RECORD IN WRITING PRIOR TO THE START OF CONSTRUCTION. FAILURE BY THE CONTRACTOR TO NOTIFY THE PROJECT ENGINEER SHALL CONSTITUTE ACCEPTANCE OF FULL RESPONSIBILITY BY THE CONTRACTOR TO COMPLETE THE SCOPE OF WORK AS DEFINED BY THE DRAWINGS AND IN FULL COMPLIANCE WITH LOCAL REGULATIONS AND CODES.
- 21. CONTRACTOR IS RESPONSIBLE FOR COORDINATION OF SITE PLAN DOCUMENTS AND ARCHITECTURAL DESIGN FOR EXACT BUILDING UTILITY CONNECTION LOCATIONS, GREASE TRAP REQUIREMENTS/ DETAILS, DOOR ACCESS AND EXTERIOR GRADING. THE UTILITY SERVICE SIZES ARE TO BE DETERMINED BY THE ARCHITECT. THE CONTRACTOR SHALL COORDINATE INSTALLATION OF UTILITIES/SERVICES WITH THE INDIVIDUAL COMPANIES, TO AVOID CONFLICTS AND ENSURE PROPER DEPTHS ARE ACHIEVED. THE JURISDICTION UTILITY REQUIREMENTS SHALL ALSO BE MET. AS WELL AS COORDINATING THE UTILITY TIE-INS/CONNECTIONS PRIOR TO CONNECTING TO THE EXISTING UTILITY/SERVICE. WHERE CONFLICT EXISTS WITH THESE SITE PLANS, ENGINEER IS TO BE NOTIFIED PRIOR TO CONSTRUCTION TO RESOLVE SAME.
- 22. ALL FILL, COMPACTION AND BACKFILL MATERIALS REQUIRED FOR UTILITY INSTALLATION SHALL BE AS PER THE RECOMMENDATIONS PROVIDED IN THE GEOTECHNICAL REPORT AND SHALL BE COORDINATED WITH THE APPLICABLE
- 23. THE CONTRACTOR SHALL COMPLY TO THE FULLEST EXTENT WITH THE LATEST OSHA STANDARDS AND REGULATIONS, OR ANY OTHER AGENCY HAVING JURISDICTION FOR EXCAVATION AND TRENCHING PROCEDURES. THE CONTRACTOR IS RESPONSIBLE FOR DETERMINING "MEANS AND METHODS" REQUIRED TO MEET THE INTENT AND PERFORMANCE CRITERIA OF OSHA, AS WELL AS ANY OTHER ENTITY THAT HAS JURISDICTION FOR EXCAVATION AND/OR TRENCHING
- 24. PAVEMENT SHALL BE SAW CUT IN STRAIGHT LINES TO THE FULL DEPTH OF THE EXISTING PAVEMENT. ALL DEBRIS FROM REMOVAL OPERATIONS SHALL BE REMOVED FROM THE SITE AT THE TIME OF EXCAVATION. STOCKPILING OF DEBRIS
- 25. IN CASE OF DISCREPANCIES BETWEEN PLANS OR RELATIVE TO OTHER PLANS, THE SITE PLAN WILL TAKE PRECEDENCE. IMMEDIATELY NOTIFY THE ENGINEER IN WRITING OF ANY CONFLICTS.
- 26. CONTRACTOR SHALL BE REQUIRED TO SECURE ALL NECESSARY PERMITS AND APPROVALS FOR ALL OFF-SITE MATERIAL SOURCES AND DISPOSAL FACILITIES. CONTRACTOR SHALL SUPPLY A COPY OF APPROVALS TO ENGINEER AND OWNER PRIOR TO INITIATING WORK.
- 27. THERE IS NO NATURAL OR MAN-MADE WATERCOURSE TRAVERSING THE SITE.

OWNER / APPLICANT

2486 RIDGEWAY LLC 2486 RIDGEWAY BOULEVARD MANCHESTER, NEW JERSEY, 08759



KEY MAP SCALE: 1" = 2000'

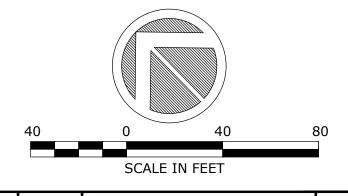

No.	DATE	DESCRIPTION	В



CONSULTING ENGINEERS, LAND SURVEYORS, PLANNERS, ENVIRONMENTAL SCIENTISTS, CONSTRUCTION SERVICES 1245 AIRPORT ROAD, SUITE 1, LAKEWOOD, NEW JERSEY 08701 PHONE 732 363 0060 FAX 732 363 0073 NEW JERSEY STATE BOARD OF P.E. & L.S. CERTIFICATE OF AUTHORIZATION NO. 24GA28125400

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PRELIMINARY & FINAL MAJOR SITE PLANS

COVER SHEET

TAX BLOCK 72.01 TAX LOT 10.01

TOWNSHIP OF MANCHESTER OCEAN COUNTY **NEW JERSEY** DRAWN BY: KNL DATE: MARCH 6, 2024 IMB SHEET: DESIGN/CALC'D BY:


BOARD CHAIRMAN


BOARD SECRETARY DATE **BOARD ENGINEER**

DATE

APPROVED BY:

THE MANCHESTER TOWNSHIP PLANNING BOARD

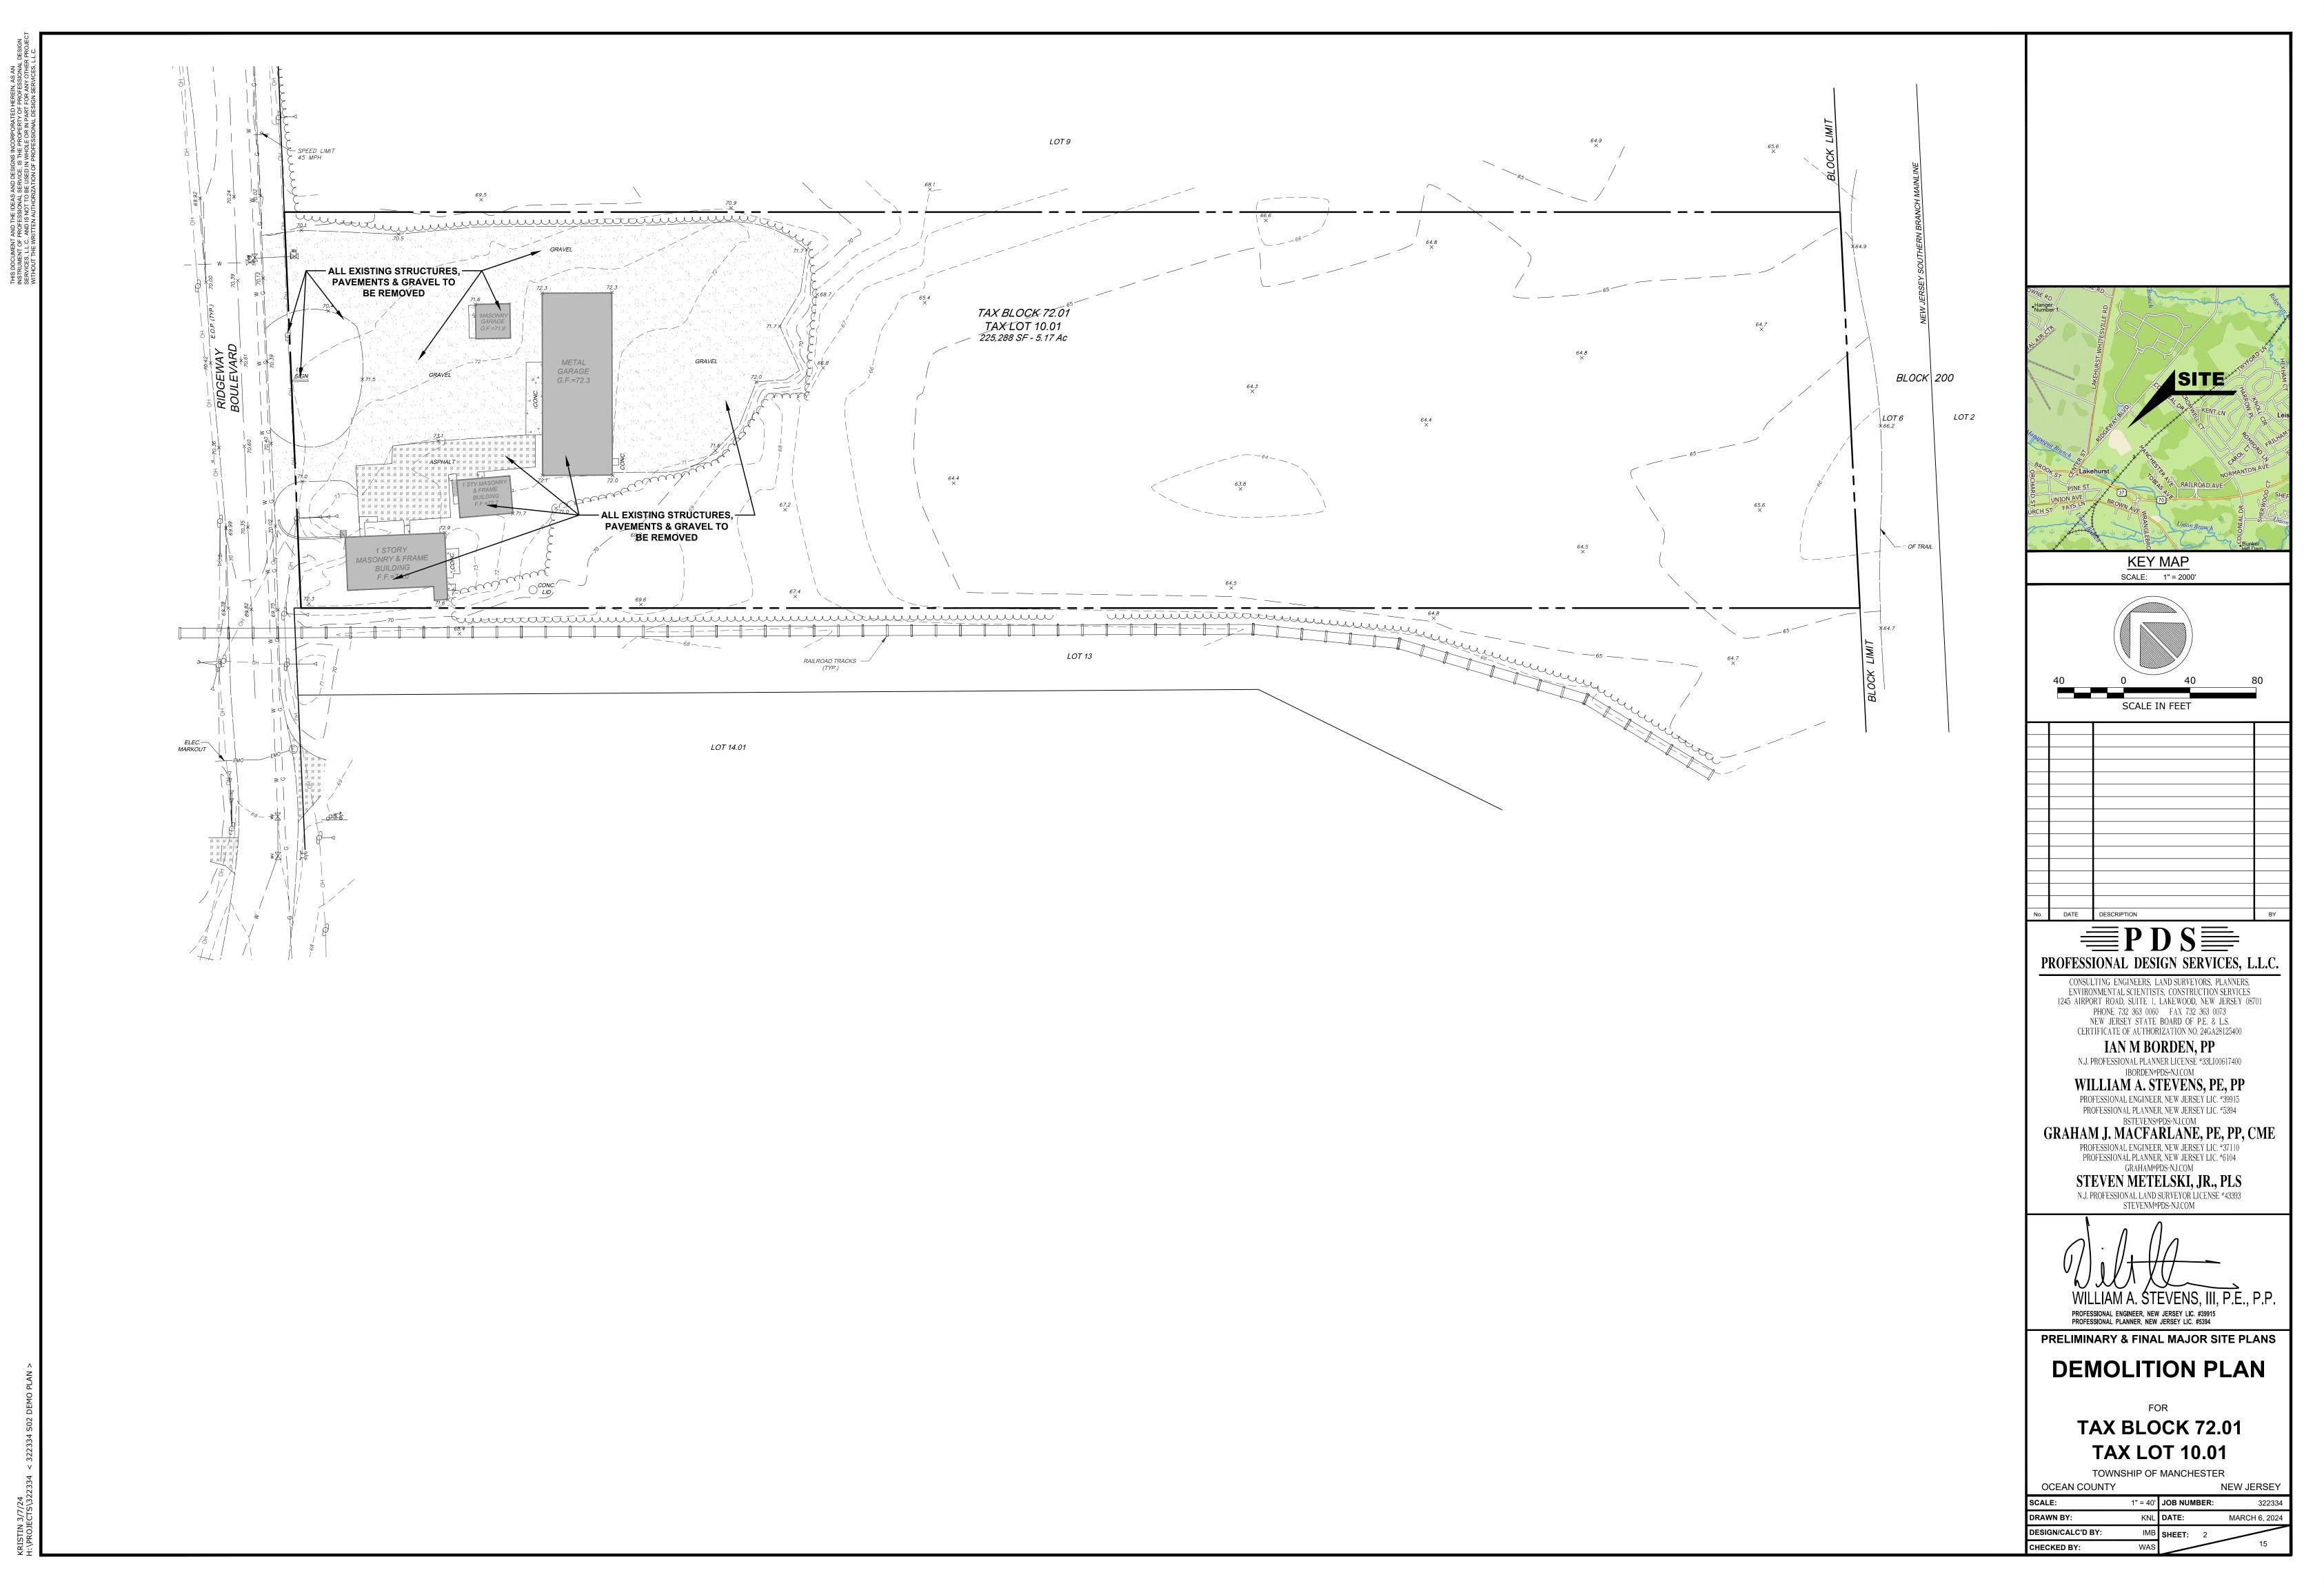

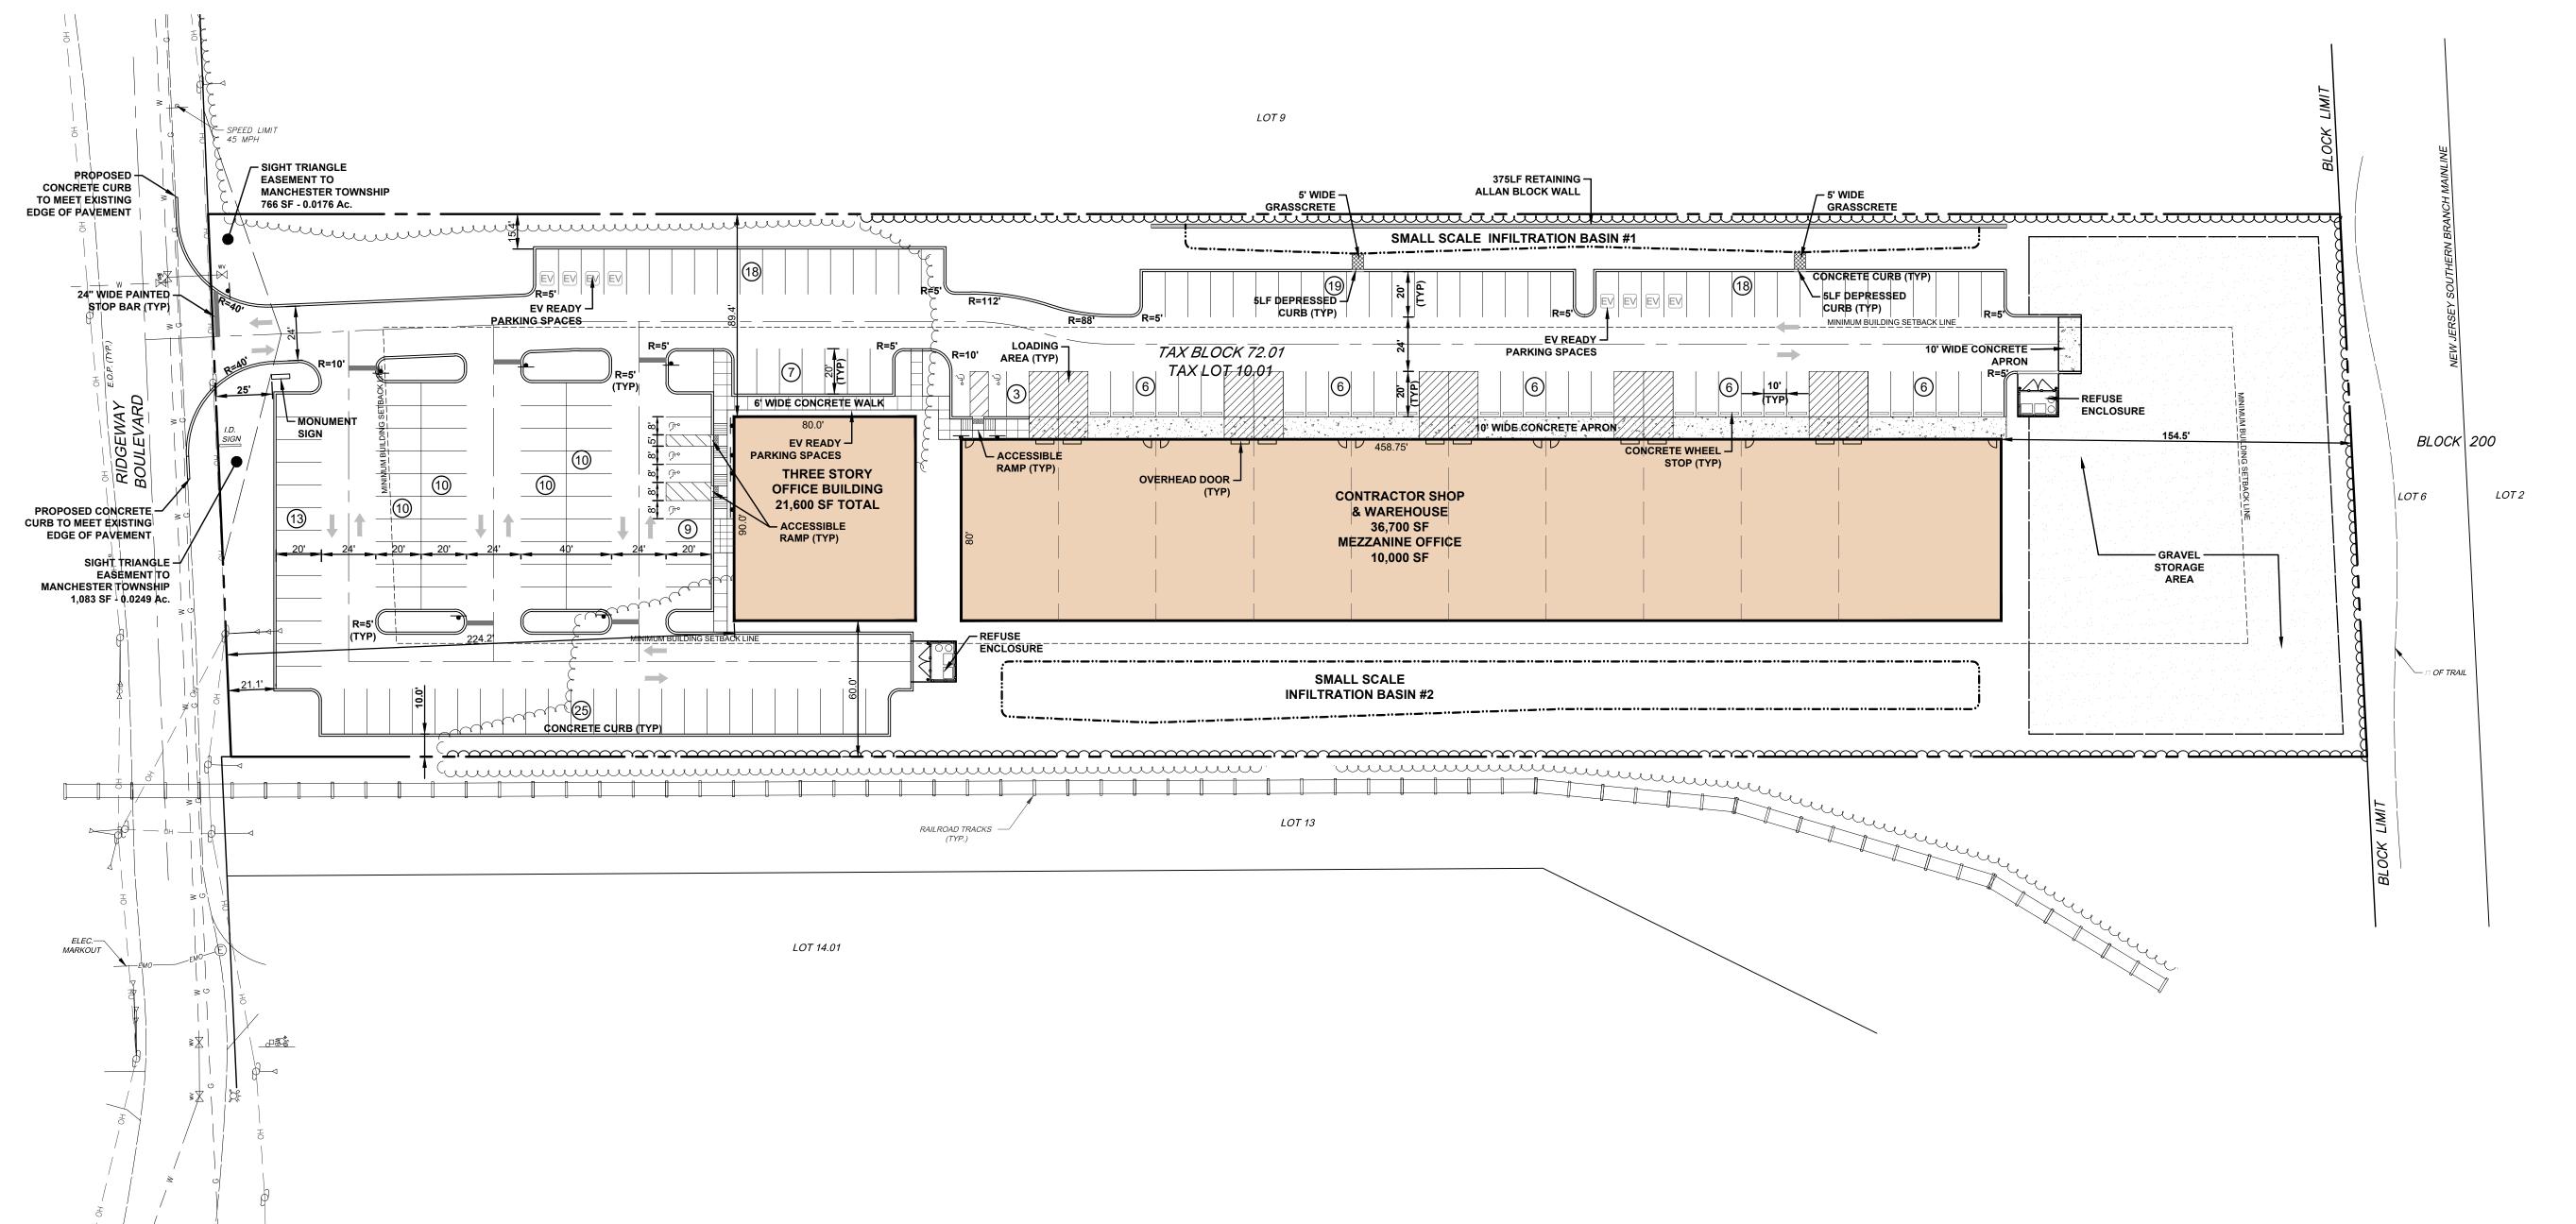


Parking Calculations							
			Parking				
Land Use	Units	Parking	Doguirod	Drovidod			
Land Ose		Required	Required	Provided			
Office	21,600	1/200 SF	108	108			
Warehouse	36,700	1/1,500 SF	24	24			
Warehouse Mezzanine Office	10,000	1/200 SF	50	50			
			182	182			
EV Ready Space Credit	8		8	8			
		Total	182	190			

POR-LI PINELANDS OFFICE, RESEARCH & LIGHT INDUSTRY ZONING REQUIREMENTS:

		_
	REQUIRED	PROPOSED
MINIMUM LOT AREA	3 ACRES	5.17 ACRES
MINIMUM LOT FRONTAGE	200 FT	239.57 FT
MINIMUM LOT WIDTH	200 FT	239.57 FT
IMPROVABLE LOT AREA	40,000 SF	>40,000 SF
PRINCIPAL BUILDING:		
MINIMUM FRONT YARD SETBACK	75 FT	224.2 FT
MINIMUM REAR YARD SETBACK	50 FT	154.5 FT
MINIMUM SIDE YARD SETBACK	50 FT	60.0 FT
ACCESSORY BUILDING:		
MINIMUM REAR YARD SETBACK	20 FT	N/A
MINIMUM SIDE YARD SETBACK	20 FT	N/A
MAXIMUM SITE IMPROVEMENT RATIO	0.2	0.2
MAXIMUM BUILDING COVERAGE	20%	19.5%
MAXIMUM LOT COVERAGE	65 %	58.8%
MAXIMUM BUILDING HEIGHT	40 FT	40 FT
MINIMUM FLOOR AREA	4,000 SF	>4,000 SF



KEY MAP SCALE: 1" = 2000'

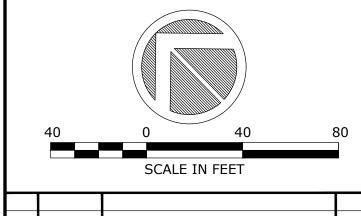

No.	DATE	DESCRIPTION	
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■ PDS ==
PROFESSIONAL DESIGN SERVICES, L.L.C

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PRELIMINARY & FINAL MAJOR SITE PLANS

SITE PLAN

FOR

TAX BLOCK 72.01 TAX LOT 10.01

TOWNSHIP OF MANCHESTER

 OCEAN COUNTY
 NEW JERSEY


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 1" = 40'
 JOB NUMBER:
 322334

 DRAWN BY:
 KNL
 DATE:
 MARCH 6, 2024

 DESIGN/CALC'D BY:
 IMB
 SHEET:
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 CHECKED BY:
 WAS
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ROJECTS\322334 < 322334 S03 SITE PLAN >



	Test Pits
TP # 1	Elevation $= 65.7$
0 - 19"	10 YR 6/1 Loamy Sand
19 - 28"	10 YR 6/8 Loamy Sand
28 - 79"	10 YR 8/6 Sand
79 - 86"	10 YR 8/4 Sand w/ variegated bands of 5/8 mottle
86 - 120"	10 YR 8/4 Sand Iron Concr & 6/8 dist mottles
	SHWT @ 86 ", Elevation 58.5
	Groundwater found at 120"
	Permeability @ 60 " = 11.5 inches per hour
TP # 2	Elevation = 64.7
0 - 4"	10 YR 5/7 Loamy Sand
4 - 12"	10 YR 6/1 Loamy Sand
12 - 55"	10 YR 6/8 Loamy Sand
55 - 81"	10 YR 8/6 Sand
81 - 120"	10 YR 8/4 Sand 6/8 mottles
	SHWT @ 81", Elevation 57.9
	No Groundwater encountered
	Permeability @ 60" = 13.5 Inches per hour
TP # 3	Elevation = 64.7
0 - 8"	10 YR 5/2 Loamy Sand
8 - 17"	10 YR 6/1 Loamy Sand
17 - 79"	10 YR 6/8 Loamy Sand
79 - 122"	10 YR 8/4 Loamy Sand iron concr & 6/8 mottle
	SHWT @ 79", Elevation = 58.1
	No Groundwater encountered
	Permeability @ 70" = 13.0 inches per hour
TP # 4	Elevation = 64.7
** 11 f	Die ration 01.7
0 - 5"	10 YR 5/2 Loamy Sand
5 - 15"	10 YR 6/1 Loamy Sand
15 - 33"	10 YR 6/8 Loamy Sand
33 - 79"	10 YR 8/4 Sand
79 - 120"	10 YR 8/4 Sand w/ iron concretions

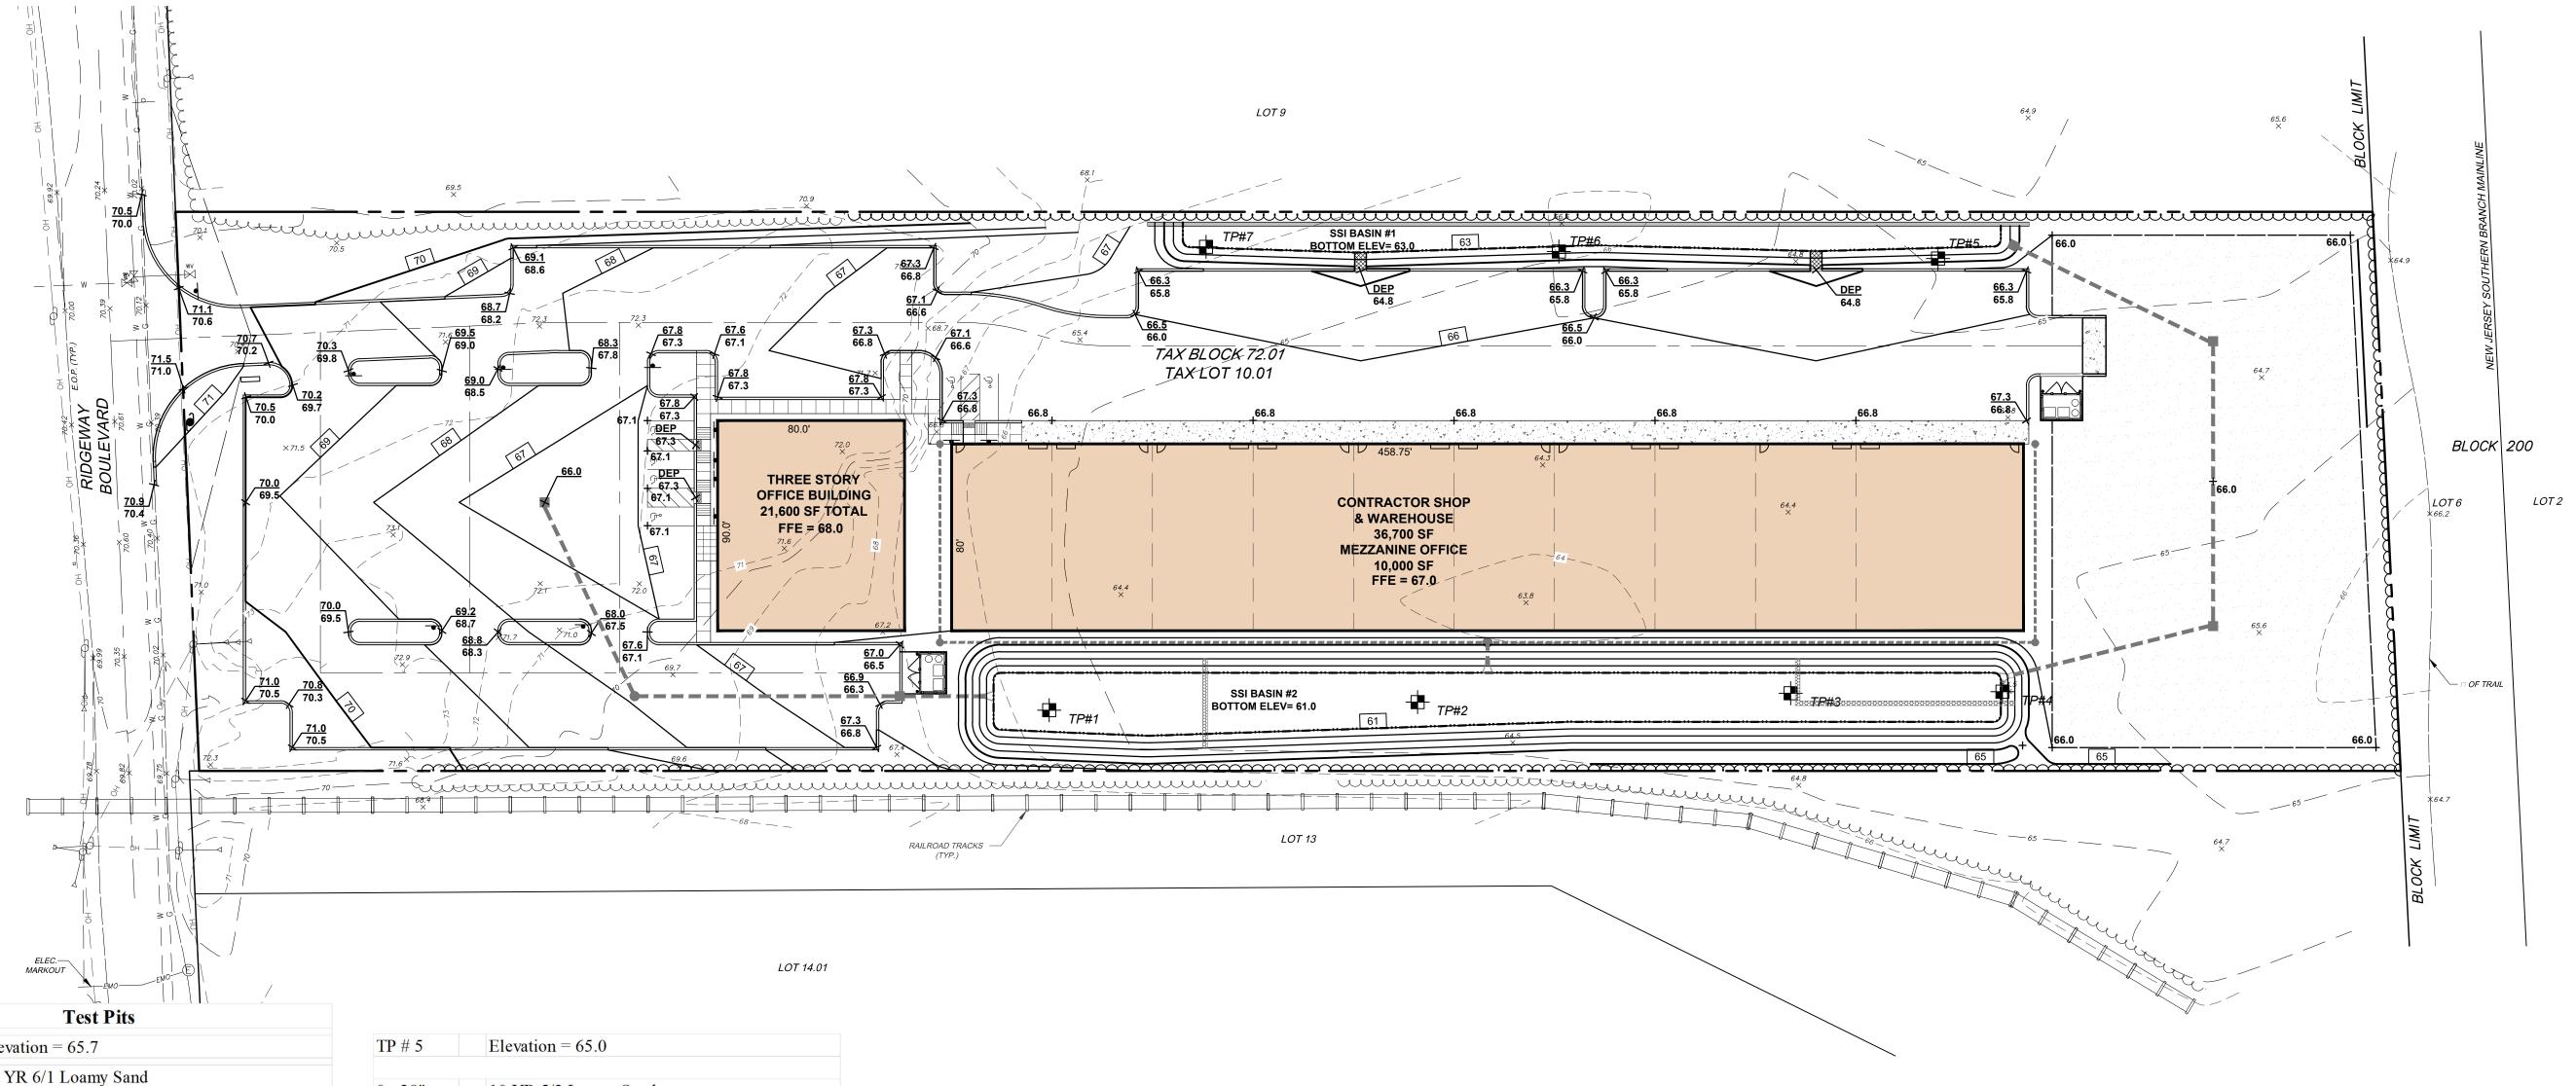SHWT @ 79", Elevation = 58.1

No Groundwater encountered

Permeability @ 65" = 15.5 Inches per hour

TP # 5	Elevation $= 65.0$
0 - 28"	10 YR 5/2 Loamy Sand
28 - 81"	10 YR 8/4 Sand
81 - 120"	10 YR 8/4 Sand w/ iron concr & 6/8 mottles
	SHWT @ 81", Elevation = 58.4
	No Groundwater encountered
	Permeability @ 84" = 15.5 Inches per hour
TP # 6	Elevation = 65.0
0 - 27"	10 YR 5/2 Loamy Sand
27 - 84"	10 YR 6/8 Loamy Sand
84 - 120"	10 YR 8/4 Sand w/ iron concr & 6/8 mottles
	SHWT @ 84", Elevation = 58.0
	No Groundwater encountered
	Permeability @ 93" = 13.0 Inches per hour
TP # 7	Elevation = 65.0
0 - 17"	10 YR 5/2 Loamy Sand
17 - 32"	10 YR 6/8 Loamy Sand
32 - 84"	10 YR 8/4 Sand
84 - 120"	10 YR 8/4 Sand w/ iron concr & 6/8 mottles
	SHWT @ 84", Elevation = 58.0
	No Groundwater encountered
	Permeability @ 65" = 15.5 Inches per hour
Test Pits ner	formed by PDS October 19, 2023

LEGEND	
EXISTING SPOT GRADE	127.32 ×
PROPOSED SPOT GRADE	115.10 +
EXISTING CONTOUR	<i>134</i>
PROPOSED CONTOUR	91
PROPOSED INLET	
PROPOSED STORM MANHOLE	•
PROPOSED FLARED END SECTION	>
PROPOSED STORM PIPE	
PROPOSED ROOF DRAINAGE	
PROPOSED CLEAN OUT	● . TP#1
PROPOSED TEST PIT	

SITE

WINDER


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NORMAN

SCALE: 1" = 2000'



No. DATE DESCRIPTION BY

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PRELIMINARY & FINAL MAJOR SITE PLANS

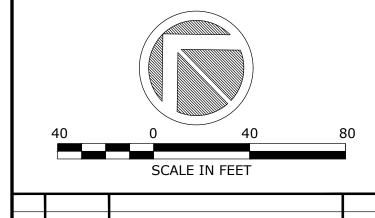GRADING PLAN

TAX BLOCK 72.01

TAX LOT 10.01
TOWNSHIP OF MANCHESTER

 OCEAN COUNTY
 NEW JERSEY


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 KNL
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 MARCH 6, 2024

 DESIGN/CALC'D BY:
 IMB
 SHEET:
 4

 CHECKED BY:
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STORMWATER BASN NOTES:

- 1. THE PROJECT DOES NOT CONTAIN ANY HIGH POLLUTANT LOADING AREAS (HPLA) AND SEGREGATION OR PRETREATMENT OF RUNOFF IS NOT
- 2. THE STORMWATER BASIN HAS BEEN DESIGNED TO MAINTAIN A MINIMUM SEPARATION OF AT LEAST TWO (2) FEET FROM THE BASIN BOTTOM TO THE SEASONAL HIGH WATER TABLE.
- 3. THE SOIL PERMEABILITY BELOW THE BASIN DOES NOT PERMEATE IN EXCESS OF 20 INCHES PER HOUR AND NO BIORETENTION SYSTEM IS REQUIRED.
- 4. A GROUNDWATER MOUNDING ANALYSIS INDICATES NO ADVERSE IMPACT TO ADJACENT WATERBODIES, WETLANDS, STRUCTURES OR SEPTICS.
- 5. THE BASIN FOREBAY SHALL SERVE AS A TEMPORARY SEDIMENT BASIN UNTIL THE DRAINAGE AREA HAS BEEN COMPLETELY STABILIZED. WHEN THE DRAINAGE SYSTEM HAS BEEN COMPLETELY STABILIZED, TWO (2) FEET OF THE BOTTOM WITHIN THE FOREBAY MUST BE EXCAVATED AND REPLACED WITH CLEAN SAND HAVING A PERMEABILITY OF 6 TO 20 INCHES PER HOUR.
- 6. CARE MUST BE TAKEN DURING CONSTRUCTION TO MINIMIZE COMPACTION OF THE BASIN BOTTOM. THE BASIN AREA MUST BE RENOVATED AND TILLED AFTER CONSTRUCTION IS COMPLETED AND THE DRAINAGE AREA IS STABILIZED. NO EARTHWORK MAY BE PERFORMED WHEN SOIL MOISTURE CONTENT IS ABOVE THE LOWER PLASTIC LIMIT.
- 7. ONCE THE BASIN IS COMPLETED AND THE DRAINAGE AREA IS STABILIZED, FIELD PERMEABILITY TESTS MUST BE PERFORMED AND SUBMITTED TO THE TOWNSHIP ENGINEER TO ASSURE COMPLIANCE WITH THE DESIGN PERMEABILITY.
- 8. AS-BUILT PLANS MUST BE PERFORMED OF THE COMPLETED BASIN AND SUBMITTED TO THE TOWNSHIP ENGINEER TO ASSURE COMPLIANCE WITH THE DESIGN.
- 9. THE BASIN MUST BE DEED RESTRICTED TO PERMANENTLY PROTECT IT FROM FUTURE DEVELOPMENT.


LEGEND

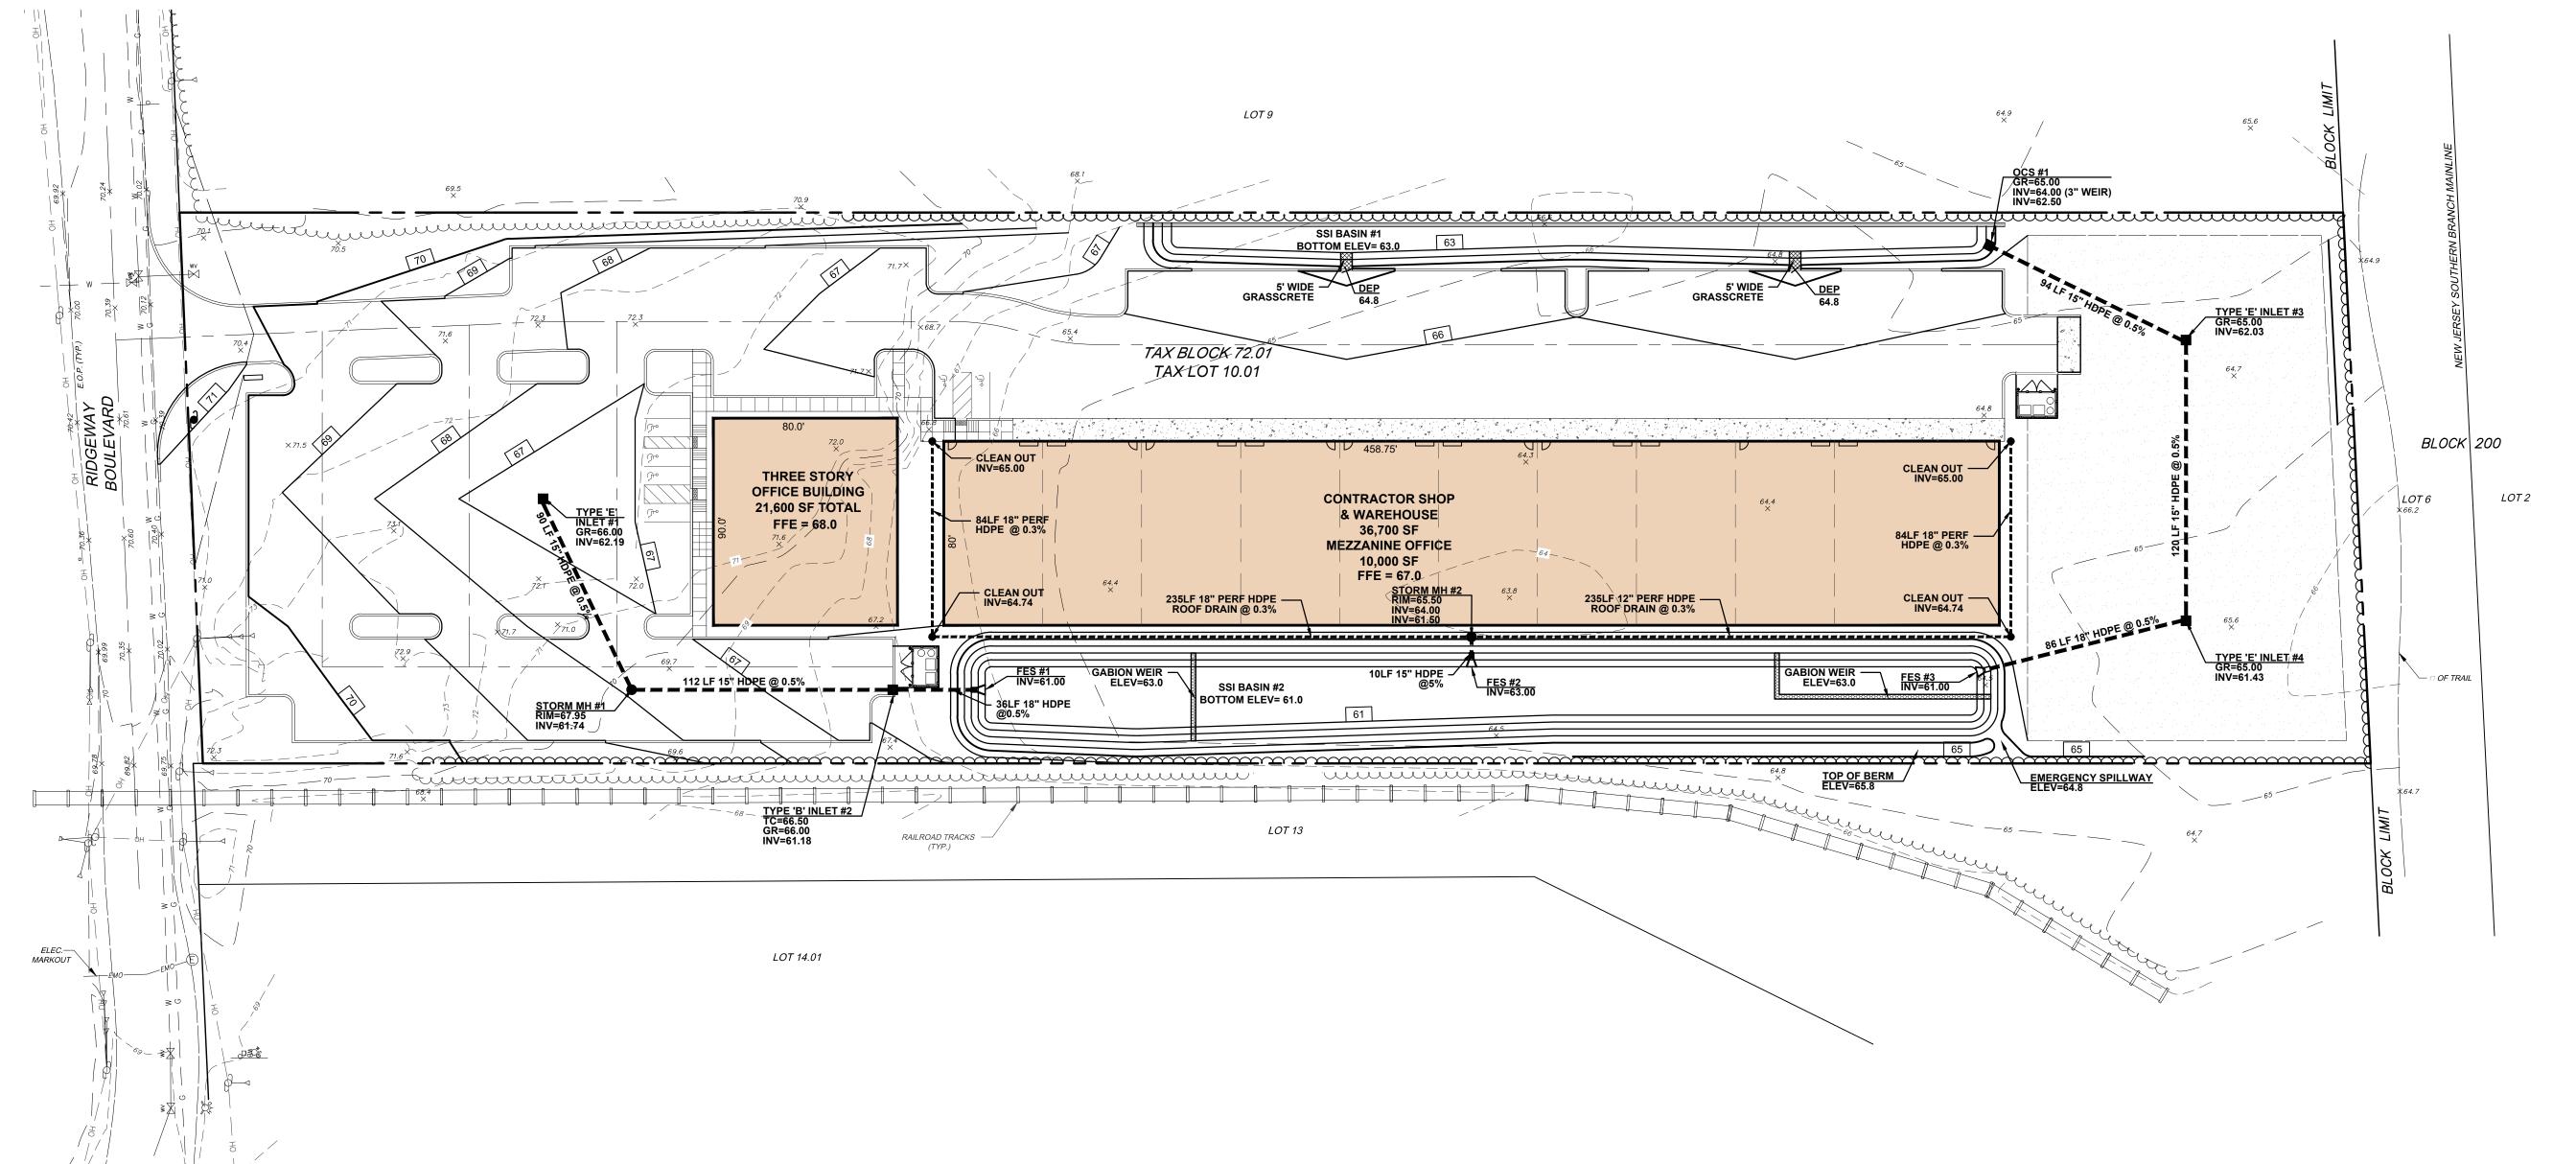PROPOSED TEST PIT

EXISTING SPOT GRADE	127.32 ×
PROPOSED SPOT GRADE	115.10 +
EXISTING CONTOUR	<i>134</i>
PROPOSED CONTOUR	91
PROPOSED INLET	•
PROPOSED STORM MANHOLE	•
PROPOSED FLARED END SECTION	>
PROPOSED STORM PIPE	
PROPOSED ROOF DRAINAGE	
PROPOSED CLEAN OUT	• TD#4



KEY MAP SCALE: 1" = 2000'

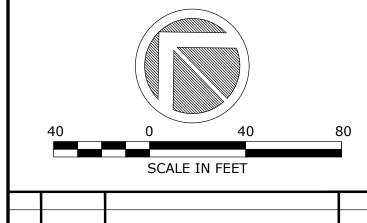

		SCALE IN FEET	
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No.	DATE	DESCRIPTION	



PROFESSIONAL DESIGN SERVICES, L.L.O

CONSULTING ENGINEERS, LAND SURVEYORS, PLANNERS, ENVIRONMENTAL SCIENTISTS, CONSTRUCTION SERVICES 1245 AIRPORT ROAD, SUITE 1, LAKEWOOD, NEW JERSEY 08701 PHONE 732 363 0060 FAX 732 363 0073 NEW JERSEY STATE BOARD OF P.E. & L.S.

CERTIFICATE OF AUTHORIZATION NO. 24GA28125400

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PRELIMINARY & FINAL MAJOR SITE PLANS

STORM DRAINAGE PLAN

FOR

TAX BLOCK 72.01 TAX LOT 10.01

TOWNSHIP OF MANCHESTER
OCEAN COUNTY NEW JERSEY


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9. ALL WATER MAINS SHALL BE CLASS 52, CEMENT LINED DUCTILE IRON PIPE,

MECHANICAL JOINT TYPE.


RATED AT 150 PSI MINIMUM. PIPE JOINTS SHALL BE OF PUSH-ON TYPE OR

IRRIGATION FOR LANDSCAPING TO BE PROVIDED BY PRIVATE WELL. THE

WELL WILL PUMP LESS THAN 100,000 GALLONS PER MONTH AND A WATER

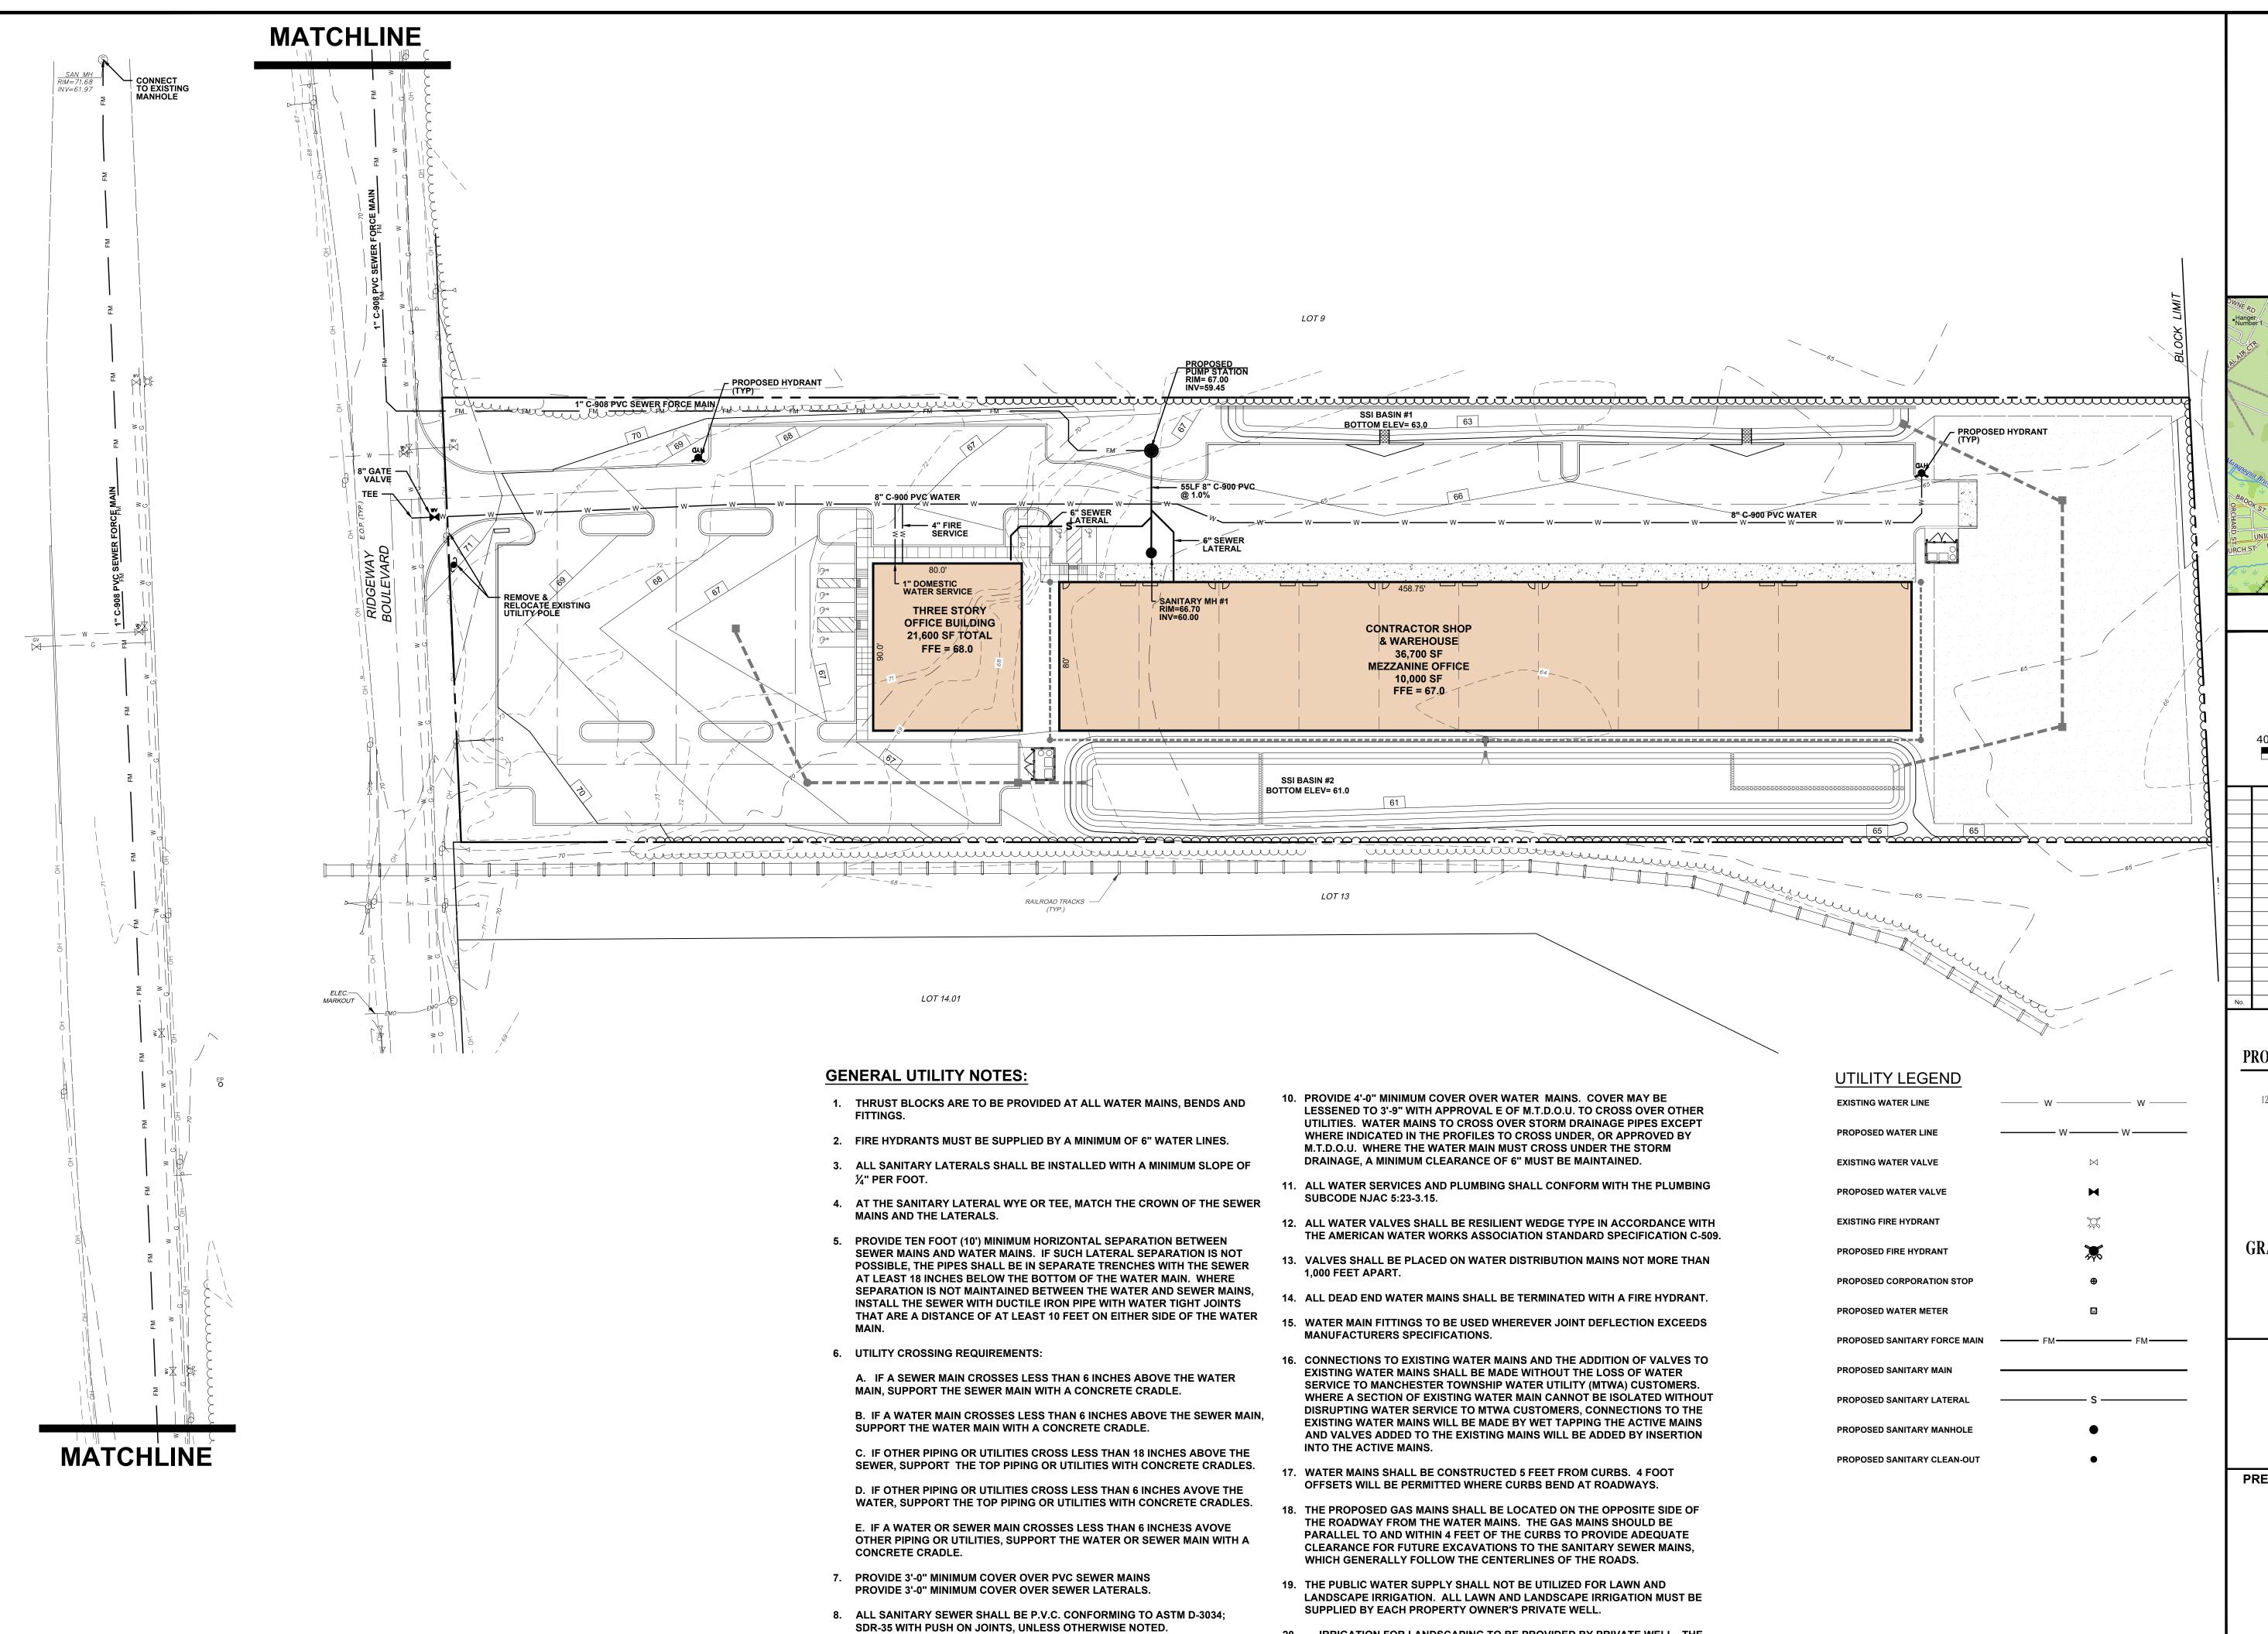DIVERSION AND ALLOCATION PERMIT WILL NOT BE REQUIRED FROM NJDEP.

KEY MAP SCALE: 1" = 2000'

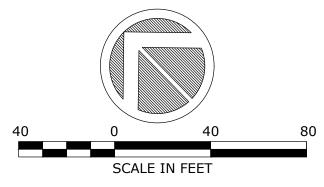



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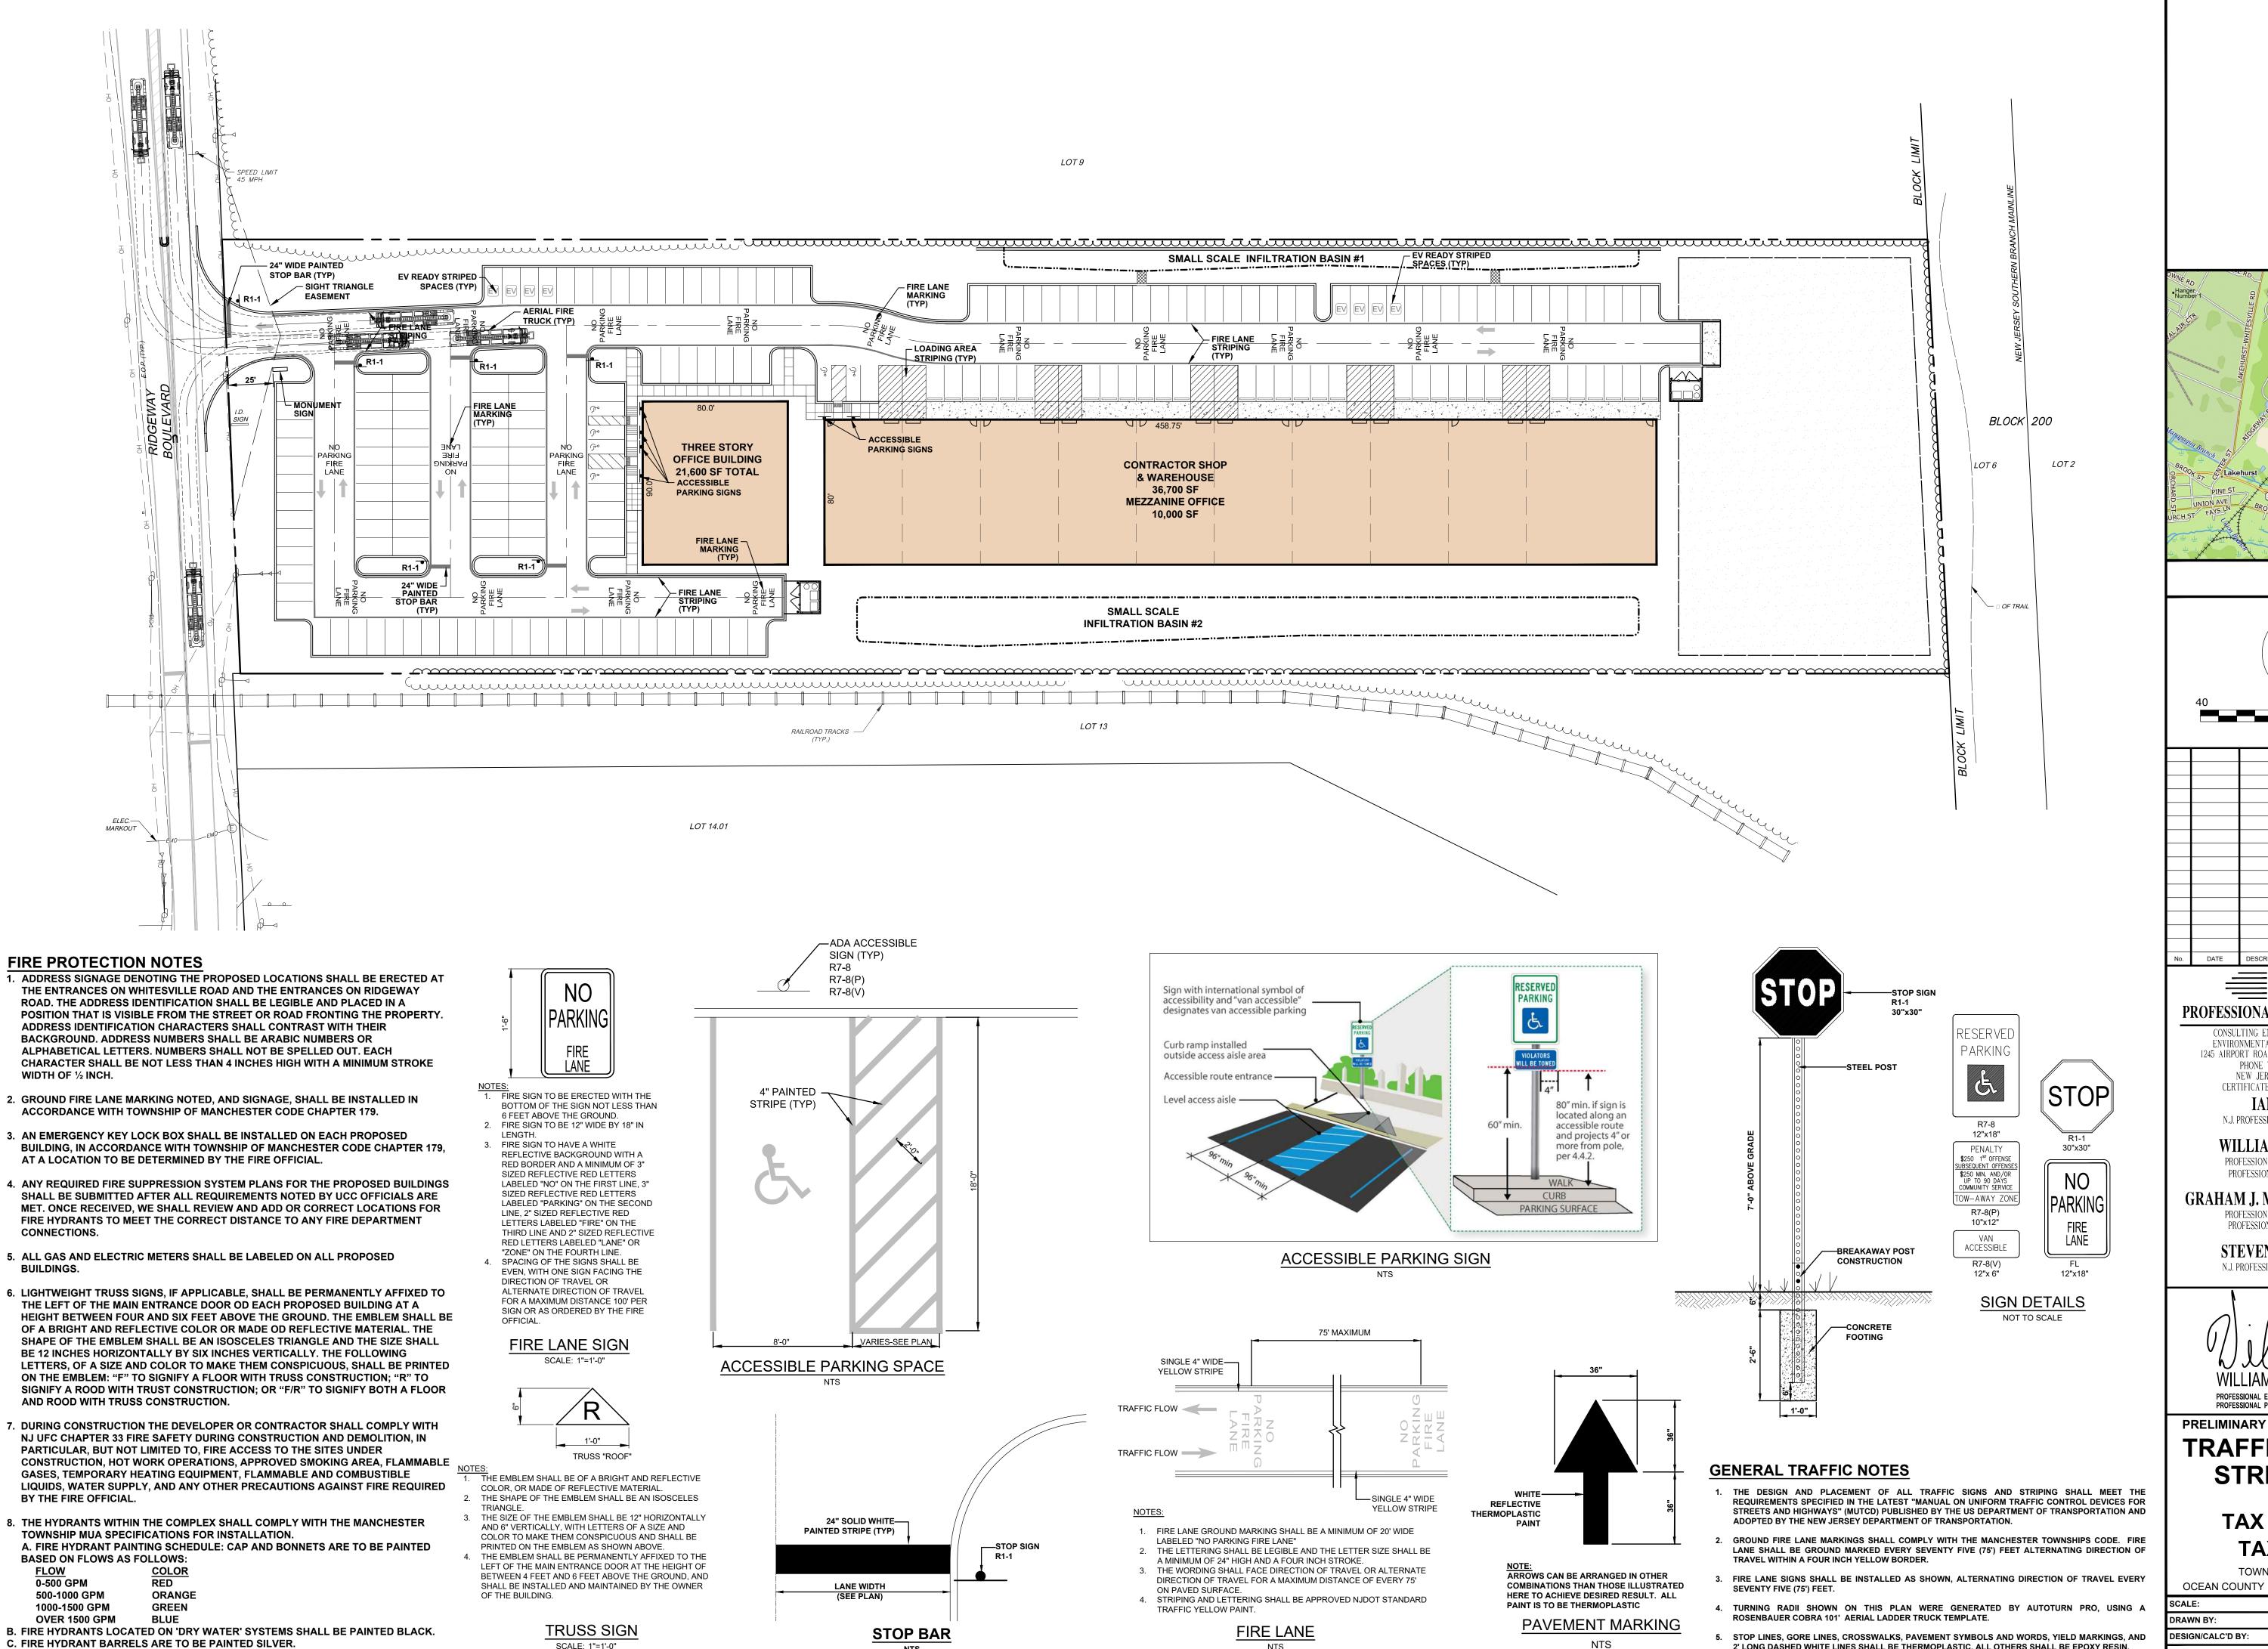
PROFESSIONAL ENGINEER, NEW JERSEY LIC. #39915 PROFESSIONAL PLANNER, NEW JERSEY LIC. #5394 PRELIMINARY & FINAL MAJOR SITE PLANS

UTILITY PLAN

TAX BLOCK 72.01 TAX LOT 10.01

> TOWNSHIP OF MANCHESTER **NEW JERSEY**

OCEAN COUNTY 1" = 40' **JOB NUMBER**: DRAWN BY: KNL DATE: MARCH 6, 2024 IMB SHEET: DESIGN/CALC'D BY: CHECKED BY:



KEY MAP SCALE: 1" = 2000'

SCALE IN FEET

$\blacksquare PDS \blacksquare$

PROFESSIONAL DESIGN SERVICES, L.L.O CONSULTING ENGINEERS, LAND SURVEYORS, PLANNERS,

ENVIRONMENTAL SCIENTISTS, CONSTRUCTION SERVICES 1245 AIRPORT ROAD, SUITE 1, LAKEWOOD, NEW JERSEY 08701 PHONE 732 363 0060 FAX 732 363 0073 NEW JERSEY STATE BOARD OF P.E. & L.S.

CERTIFICATE OF AUTHORIZATION NO. 24GA28125400 IAN M BORDEN, PP

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PRELIMINARY & FINAL MAJOR SITE PLANS


TRAFFIC SIGNAGE & STRIPING PLAN

TAX BLOCK 72.01 TAX LOT 10.01

TOWNSHIP OF MANCHESTER

NEW JERSEY 1" = 40' **JOB NUMBER**: DRAWN BY: KNL DATE: MARCH 6, 2024 IMB SHEET: DESIGN/CALC'D BY: CHECKED BY:

2' LONG DASHED WHITE LINES SHALL BE THERMOPLASTIC, ALL OTHERS SHALL BE EPOXY RESIN.

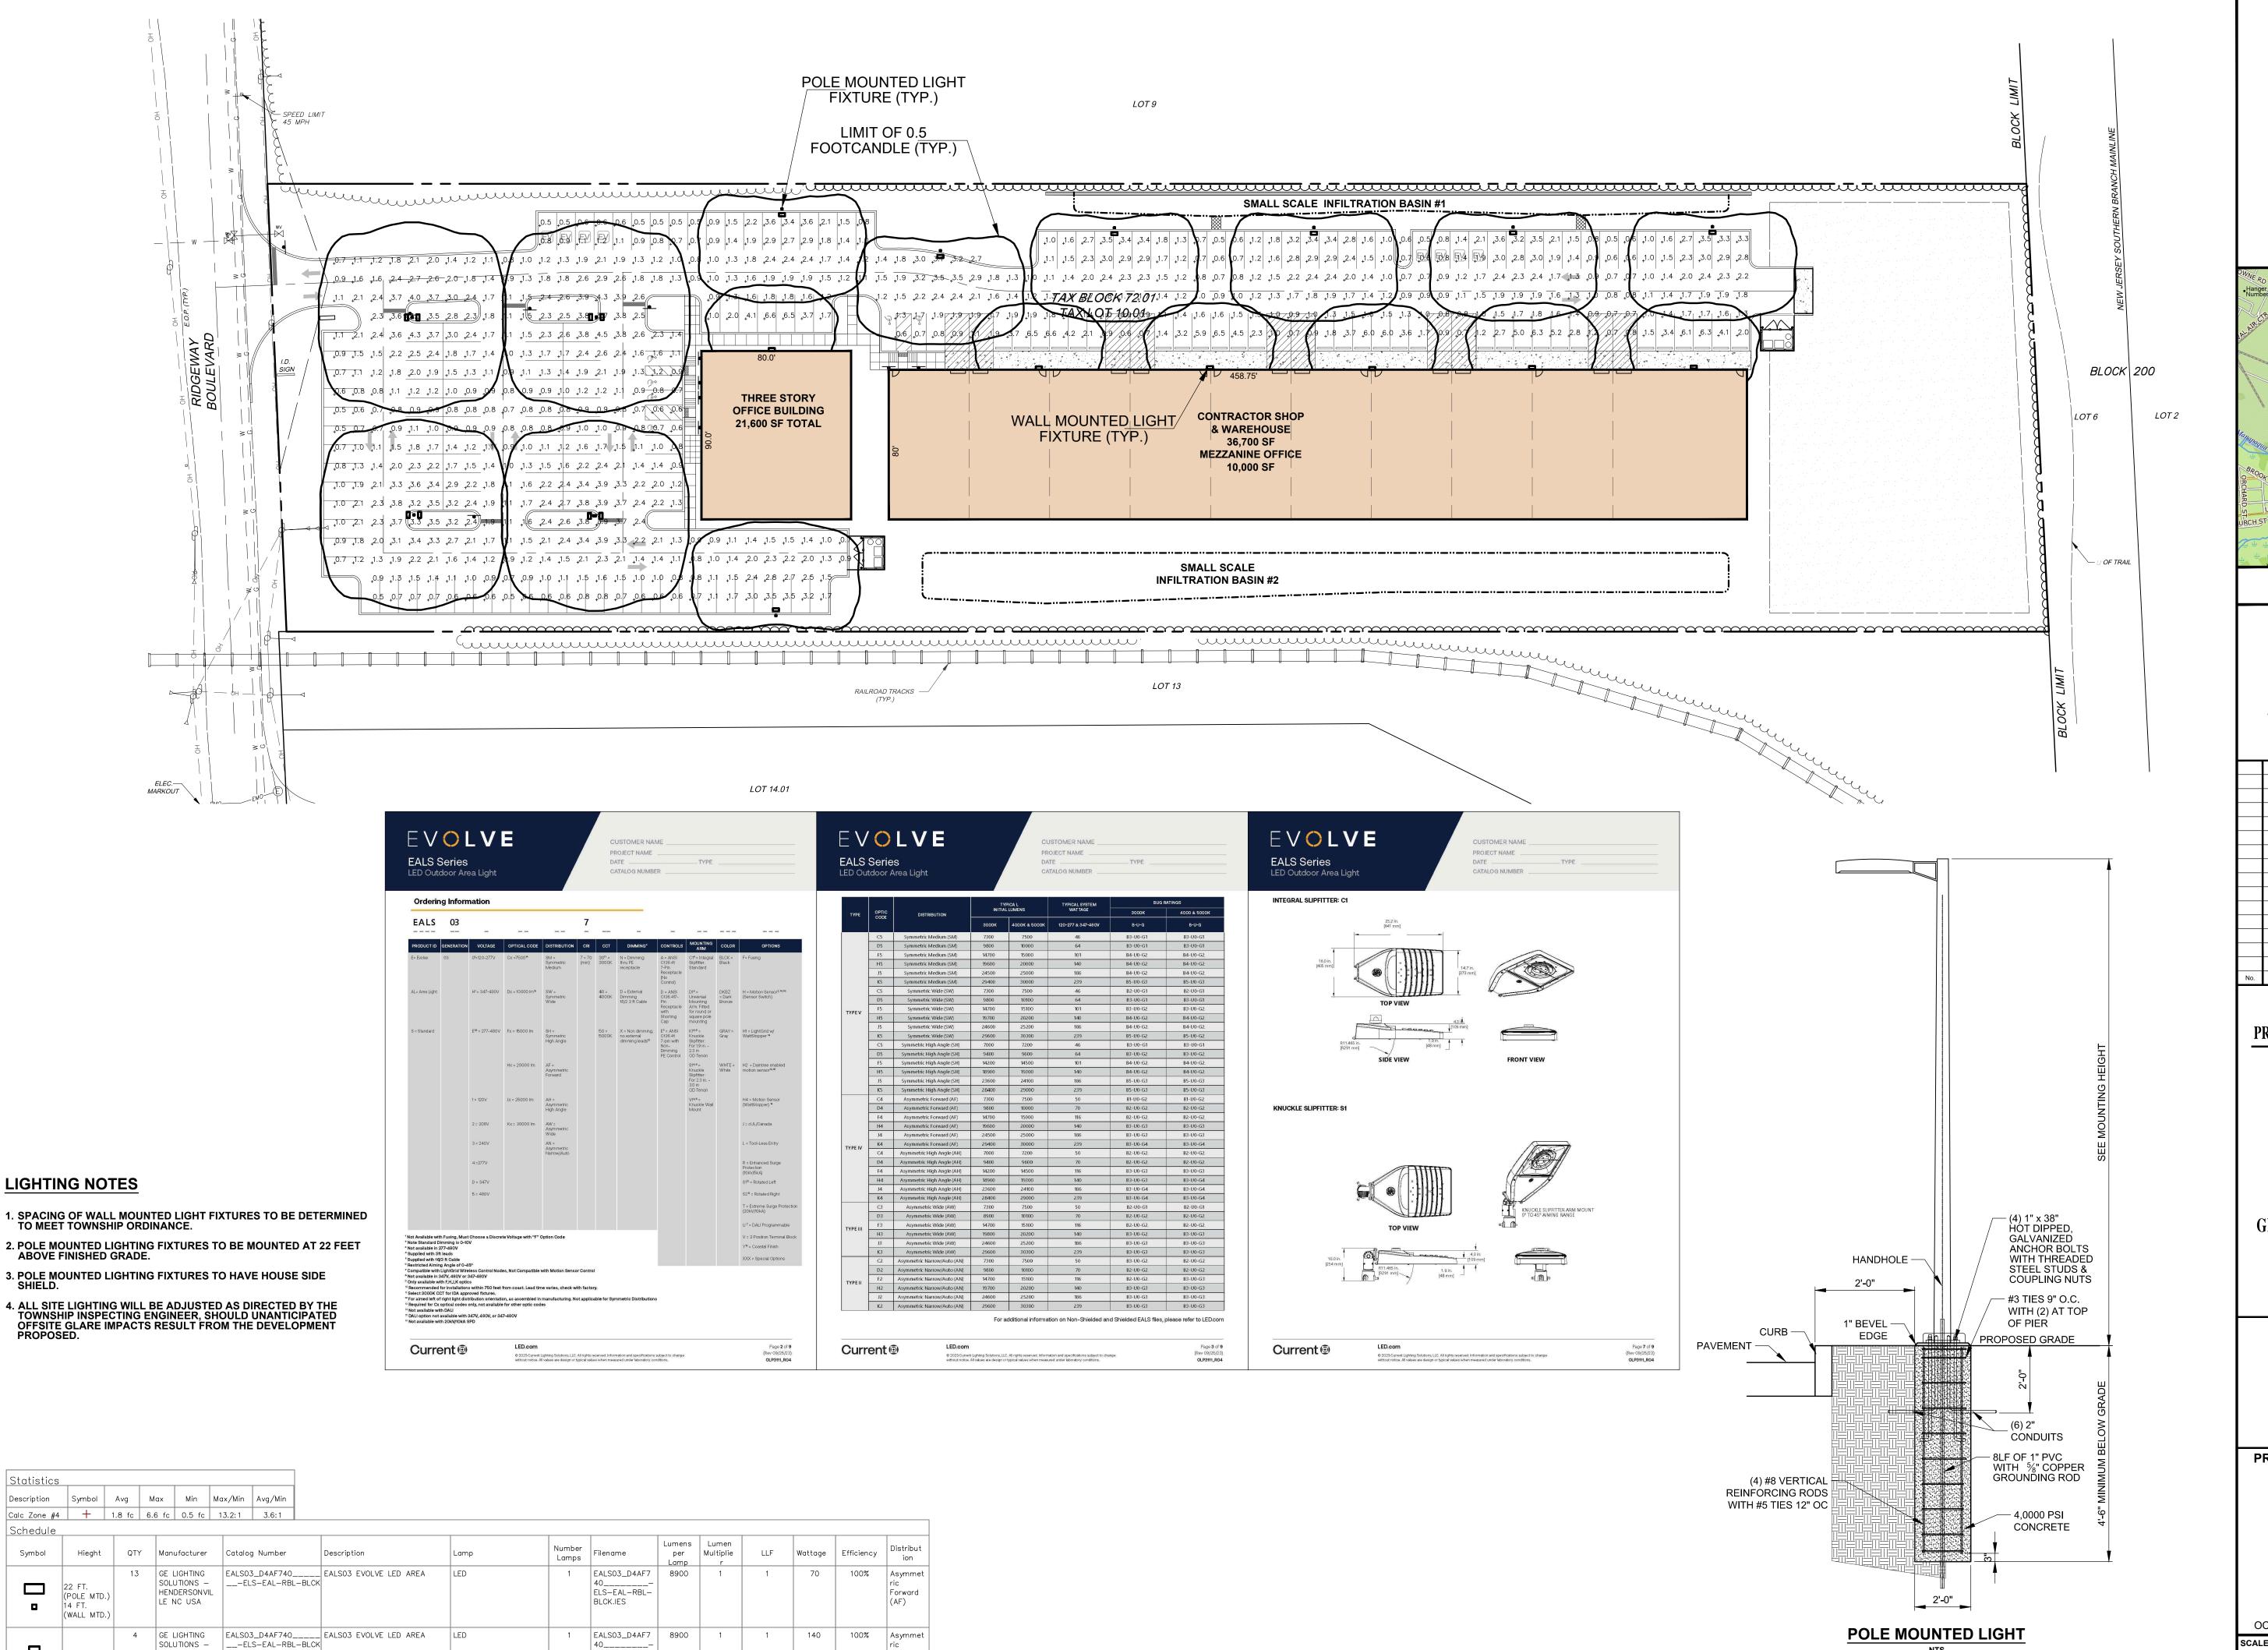

HENDERSONVIL

LE NC USA

ELS-EAL-RBL-

BLCK.IES

Forward


Hanger Number of SITE

SITE

MANUAL M

KEY MAP

SCALE: 1" = 2000'

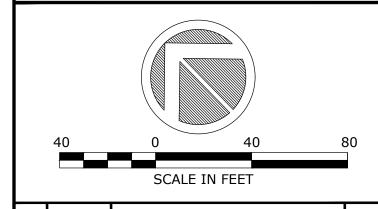

No. DATE DESCRIPTION BY



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PRELIMINARY & FINAL MAJOR SITE PLANS

LIGHTING PLAN

TAX BLOCK 72.01

TAX LOT 10.01
TOWNSHIP OF MANCHESTER


 OCEAN COUNTY
 NEW JERSEY

 SCALE:
 1" = 40'
 JOB NUMBER:
 322334

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 KNL
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 MARCH 6, 2024

 DESIGN/CALC'D BY:
 IMB
 SHEET:
 8

 CHECKED BY:
 WAS
 15

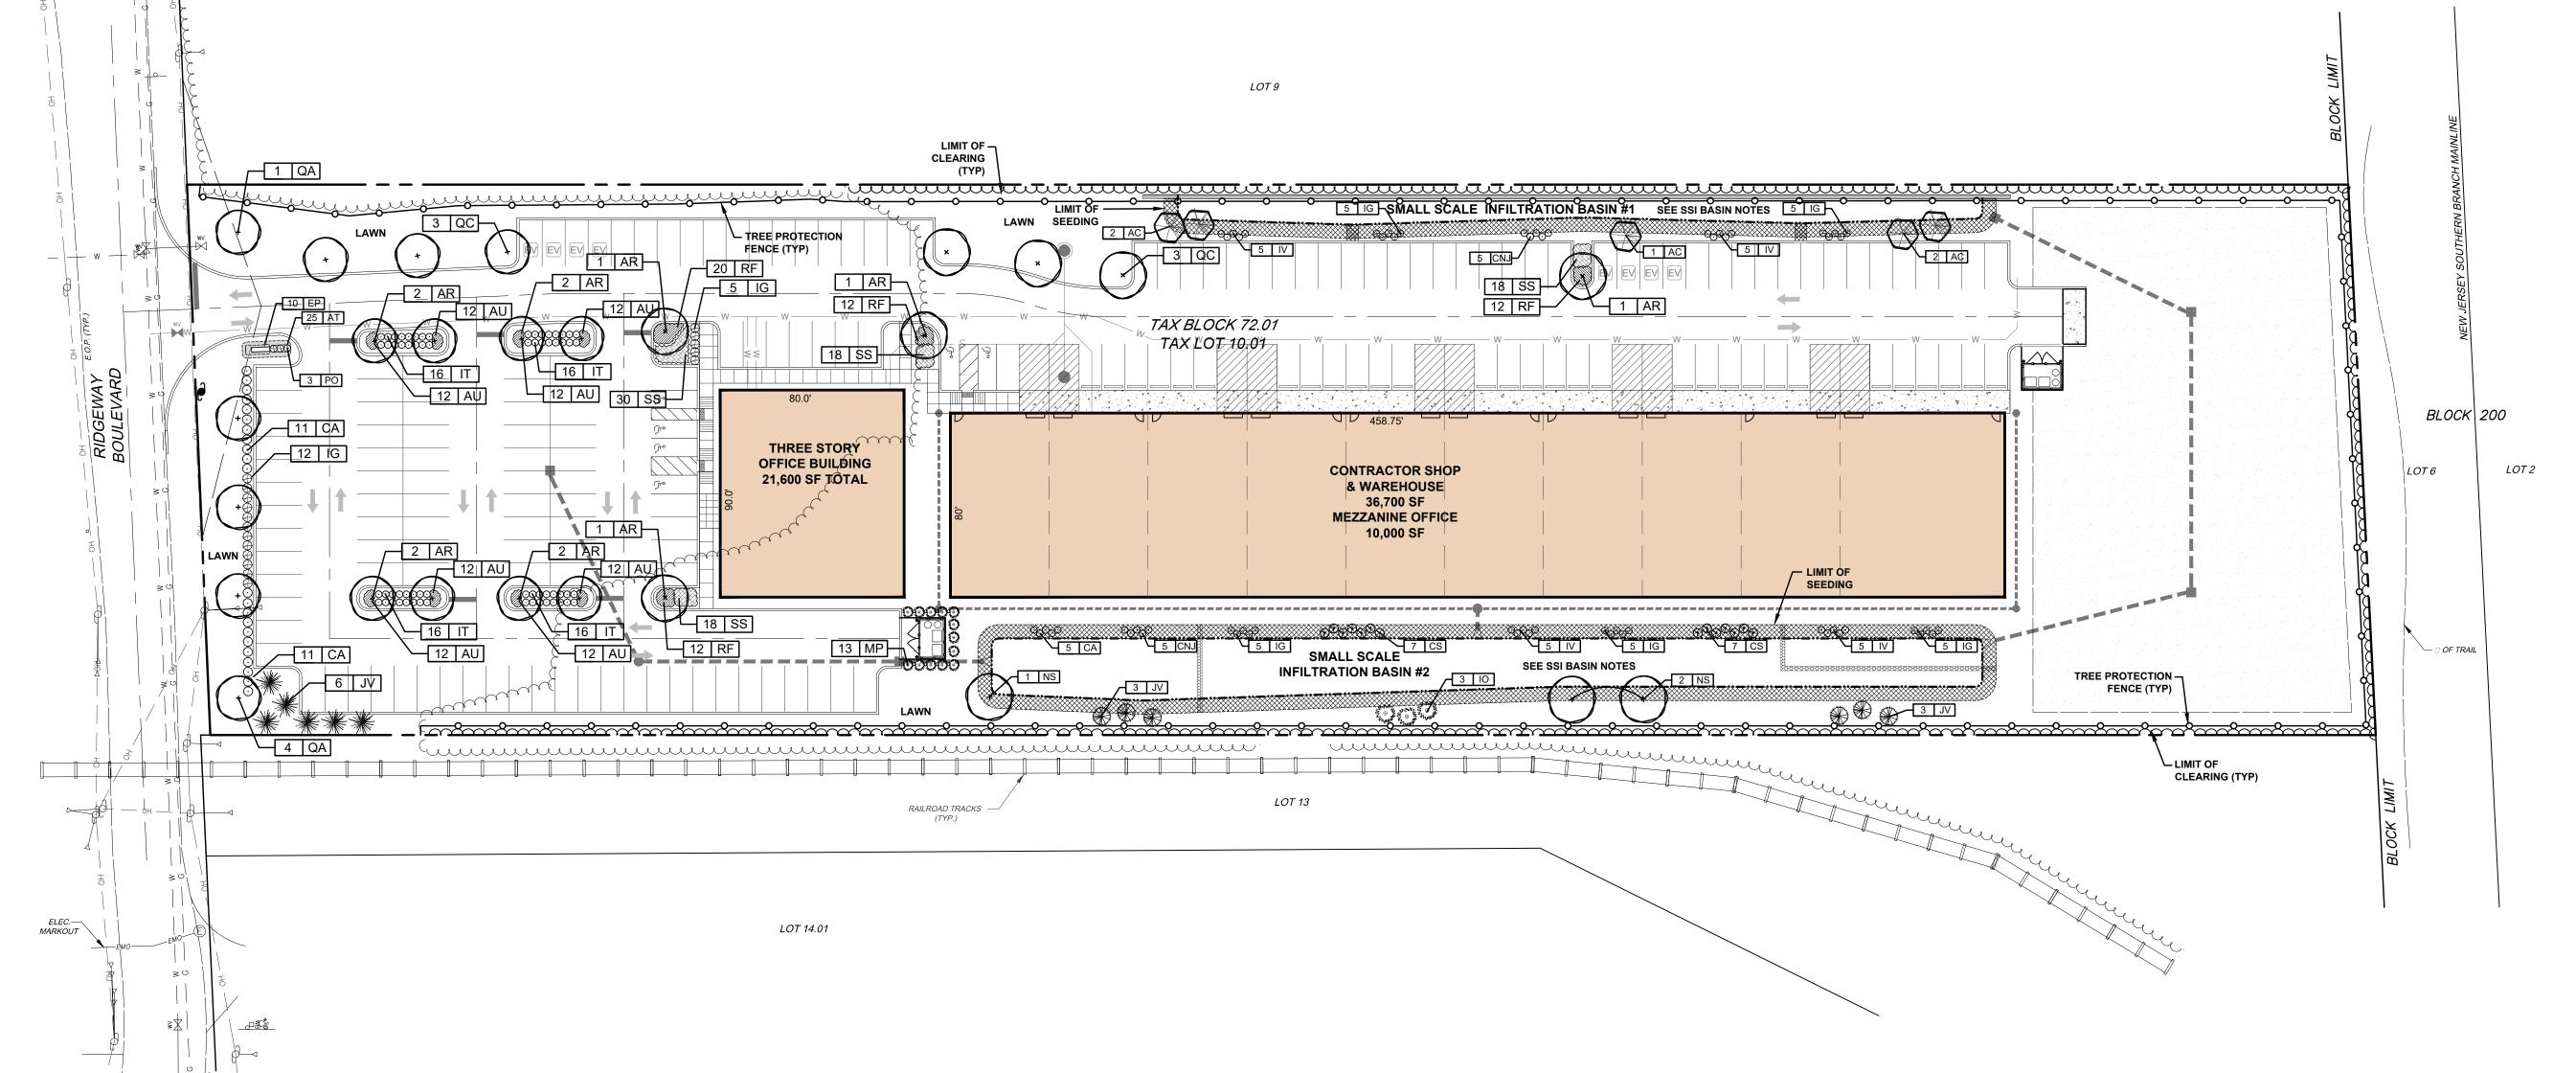

LANDSCAPE SCHEDULE:

				INSTALLED			
KEY	QTY	BOTANICAL NAME	COMMON NAME	HEIGHT	CALIPER	ROOT	COMMENTS
hade	Trees						
AR.	12	Acer buergeranum	Trident Red Maple		2 ½" - 3"	B&B	Limbed up to 7'; Spring Planting Only
NS.	3	Nyssa sylvatica	Black Gum		2 ½" - 3"		Spring Planting Only
QA	5	Quercus alba	White Oak		2 ½" - 3"	B&B	Spring Planting Only
QC	6	Quercus coccinea	Scarlet Oak		2 ½" - 3"	B&B	Limbed up to 7'; Spring Planting Only
Ornar	mental Tre	ees					
AC	5	Amelanchier canadensis	Shadblow Serviceberry	6' - 8'		B&B	Multi-stem
verg	reen Tree	s					
0	3	llex opaca	American Holly	6' - 8'		B&B	Plant 2 'Jersey Knight' as pollinator
V	12	Juniperus virginiana	Eastern Red Cedar	6' - 8'		B&B	
hrub	S		,			,	•
CA	27	Clethra alnifolia 'Hummingbird'	Hummingbird Summersweet	18" - 24"		#5 CONT	
CNJ	10	Ceanothus americanus	New Jersey Tea	18" - 24"		#5 CONT	
CS	14	Cornus sericea	Red Twig Dogwood	30" - 36"		#5 CONT	
G	42	llex glabra 'Shamrock'	Shamrock Inkberry Holly	24" - 30"		#5 CONT	
Т	64	Itea virginana	Virginia Sweetspire	24" - 30"		#5 CONT	
V	20	llex verticillata 'Winter Red'	Winter Red Winterberry	30" - 36"		#5 CONT	
MP	13	Myrica pennsylvanica	Northern Bayberry	18" - 24"		#5 CONT	
0	3	Prunus laurocerasus 'Otto Luyken'	Otto Luyken Laurel	30" - 36"		#7 CONT	
Grour	ndcover						
U	96	Arctostaphylos uva-ursi	Bearberry	15" - 18"		#1 CONT	Plant 18" On Center Spacing
Grass	es/Pereni	nials					
Υ Τ	25	Amsonia tabernaemontana	Storm Cloud Bluestar			2 GAL	18" On Center Spacing
P	10	Echinacea purpurea	Eastern Purple Coneflower			2 GAL	18" On Center Spacing
RF	56	Rudbeckia fulgida 'Goldstrum'	Black Eyed Susan			2 GAL	18" On Center Spacing
SS	84	Schizachyrium scoparium 'Jazz'	Jazz Little Bluestem			2 GAL	18" On Center Spacing

LANDSCAPE LEGEND

SHADE TREE

ORNAMENTAL TREE

EVERGREEN

SHRUB

EXISTING TREE

EXISTING TREE TO REMAIN

EXISTING TREE TO BE
REMOVED

TREE CLEARING LIMIT

TREE PROTECTION FENCE
PLANT KEY


PLANT QUANTITY

SSI BASIN NOTES:

- 1. SSI BASIN BOTTOM TO BE 6" K-5 SAND.
- SSI BASIN SLOPE TO BE SEEDED WITH "RAIN GARDEN MIX" SEED AS MANUFACTURED BY PINELANDS NURSERY & SUPPLY, COLUMBUS, NJ OR APPROVED EQUAL. COVERAGE RATE: 11 LBS / ACRE.
- 3. SSI BASINS ARE TO BE PLANTED TO REDUCE WEEKLY MOWING OPERATIONS AND CHEMICAL TREATMENTS. THE AREA SHOULD NOT BE MAINTAINED AS CONVENTIONAL LAWN AREAS.



SCALE: 1" = 2000'

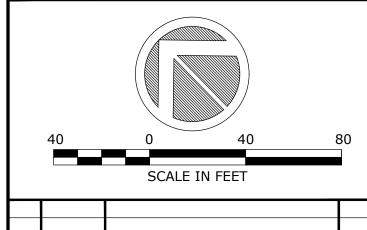

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PRELIMINARY & FINAL MAJOR SITE PLANS

LANDSCAPE PLAN

FOR

TAX BLOCK 72.01 TAX LOT 10.01

TOWNSHIP OF MANCHESTER

 OCEAN COUNTY
 NEW JERSEY

 SCALE:
 1" = 40'
 JOB NUMBER:
 322334

 DRAWN BY:
 KNL
 DATE:
 MARCH 6, 2024

 DESIGN/CALC'D BY:
 IMB
 SHEET:
 9

 CHECKED BY:
 WAS
 15

LANDSCAPE NOTES

GENERAL NOTES

- A. THIS PLAN SHALL BE UTILIZED FOR LANDSCAPE AND TREE SAVE USES ONLY. PLEASE REFER TO SITE PLANS FOR CONSTRUCTION OF SITE IMPROVEMENTS.
- B. ALL TREES ARE DRAWN TO THEIR ANTICIPATED MATURE DRIPLINE.
- C. CONTRACTOR SHALL EXAMINE DRAWINGS AND REQUEST A MARKOUT OF FIELD CONDITIONS FOR SPECIFIC LOCATIONS OF UTILITIES, STRUCTURES, ETC. NOTIFY THE ENGINEER IN WRITING IMMEDIATELY, IN REFERENCE TO DISCREPANCIES OR LOCATION CONFLICTS.
- D. IN THE EVENT THAT PLANT QUANTITY DISCREPANCIES OR MATERIAL OMISSIONS OCCUR IN THE PLANTING SCHEDULE, THE PLAN SHALL SUPERSEDE.
- ALL PLANTING MATERIAL AND METHODS SHALL MEET OR EXCEED THE REQUIREMENTS OF THE MUNICIPAL ORDINANCES OF THE TOWNSHIP OF MANCHESTER AND ANSI Z-60.1 (CURRENT VERSION), "THE AMERICAN STANDARD FOR NURSERY STOCK," PUBLISHED BY THE AMERICAN ASSOCIATION OF NURSERYMEN. IN THE EVENT OF CONFLICT BETWEEN A.A.N. AND MUNICIPAL STANDARDS, THE MUNICIPAL REQUIREMENTS SHALL SUPERCEDE.
- ALL LANDSCAPING SHALL BE PLANTED SO AS TO NOT INTERFERE WITH UTILITY LINES, SIGHT FRIANGLES, UNDERGROUND UTILITIES, PUBLIC WALKWAYS OR OTHER EXISTING OR PROPOSED STRUCTURES. ALL PLANT MATERIAL PROPOSED WITHIN THE REQUIRED SIGHT DISTANCES OR SIGHT TRIANGLES ARE SELECTED SO AS TO NOT EXCEED A MATURE HEIGHT GREATER THAN 30" ABOVE THE ELEVATION OF THE ADJACENT ROADWAY. STREET TREES AND SHADE TREES PLANTED NEAR PEDESTRIAN OR VEHICULAR ACCESSES, OR WITHIN REQUIRED SIGHT DISTANCES / SIGHT TRIANGLE EASEMENTS SHALL NOT BE BRANCHED ANY LOWER THAN 7'-0" ABOVE GRADE, AND MUST BE APPROPRIATELY PRUNED. NO WOODY PLANTS, EXCEPT GROUND COVERS, ARE TO HAVE THEIR CENTERS CLOSER THAN 36" TO THE BACK OF THE CURB. NO STREET TREES ARE TO BE PLANTED IN SIGHT TRIANGLES IN ACCORDANCE WITH MANCHESTER TOWNSHIP ORDINANCE.

2. PLANTING

- A. SOIL MUST BE FROST-FREE, FRIABLE AND NOT MUDDY AT THE TIME OF PLANTING.
- BACKFILL MATERIAL FOR PLANTING PITS SHALL BE COMPOSED OF 70% TOPSOIL, 20% FULLY COMPOSTED COW OR HORSE MANURE AND 10% PEAT MOSS. TOPSOIL SHALL MEET NJDOT 2007 STANDARD SPECIFICATIONS SECTION 917.01. AND MAY BE FROM ON-SITE OR IMPORTED SOURCES. SOIL SHALL CONTAIN NO ACIDIC MARL, NOR ANY LARGE STONES.
- C. PLANTS SHALL BE SET TO ULTIMATE FINISHED GRADE SO THAT THEY WILL BE LEFT IN THE RELATIONSHIP TO THE SURROUNDING GROUND AS THEY HAD, PRIOR TO BEING DUG. IF EVIDENCE OF SATURATED SOILS IS ENCOUNTERED DURING EXCAVATION OF THE PLANTING PITS. UPON DIRECTION BY THE ENGINEER. PLANTS SHALL BE SET SO THAT THEIR ROOT CROWNS ARE APPROXIMATELY THREE INCHES ABOVE THE FINAL GRADE. WITH TOPSOIL AND MULCH GENTLY MOUNDED TO AVOID EXCESSIVE DRYING AT THE SURFACE. UNDER NO CIRCUMSTANCES SHALL PLANTINGS AT RELATIVELY DRY LOCATIONS BE PERFORMED IN A MOUNDED MANNER.
- D. THE CORD BINDING THE BALL OF ALL BALLED AND BURLAPPED (B&B) PLANTS SHALL BE CUT AND REMOVED. AND BURLAP ON THE UPPER 1/2 OF THE ROOT BALL SHALL BE REMOVED. PLANTS WITH SYNTHETIC NON-DEGRADEABLE ROOT BALL WRAPS SHALL NOT BE ACCEPTABLE.
- E. ALL WIRE BASKETS MUST BE REMOVED PRIOR TO PLANTING.
- F. ALL PROPOSED TREES SHALL BE SET IN BEDS MULCHED TO THE LIMIT OF THEIR PLANTING PITS EXCEPT AS NOTED ALL OTHER TYPES OF PLANTINGS SHALL BE SET IN CONTINUOUS MASSED PLANTING BEDS RATHER THAN ISOLATED INDIVIDUALS. ALL TREE AND SHRUB BEDS SHALL RECEIVE A 3" THICK APPLICATION OF A THOROUGHLY COMPOSTED ORGANIC MULCH FREE FROM ANY OBJECTIONABLE OR FOREIGN MATERIALS
- G. THE MULCH AT THE OUTER PERIMETER OF PLANTING PITS AND BEDS SHALL BE PREPARED SO THAT A 2" HIGH RIM TO RETAIN MOISTURE IS CONSTRUCTED. THE THICKNESS OF THE MULCH SHALL BE FEATHERED WITHIN 3" OF STEMS OR TRUNK. SO THAT NO MULCH IS IN DIRECT PHYSICAL CONTACT WITH THE PLANTS' BRANCHING OR TRUNKS. PLANTING OF GROUNDCOVERS MAY BE SUBSTITUTED FOR MULCH IN PARKING LOT ISLANDS.
- H. TREES SHALL NOT BE GUYED, EXCEPT IF AND WHERE REQUIRED BY THE MUNICIPALITY; WHEREIN TREES GREATER THAN FIVE FEET IN HEIGHT MAY BE STAKED AND GUYED PER THE DETAILS.

PLANT MATERIAL

- A. NO PLANT SUBSTITUTION SHALL BE ALLOWED WITH REGARD TO SIZE, SPECIES, NAMED VARIETY OR CULTIVAR, WITHOUT PRIOR PERMISSION FROM THE TOWNSHIP TREE SPECIALIST. ALL SUBSTITUTIONS SHALL BE SUBMITTED TO THE TOWNSHIP TREE SPECIALIST FOR REVIEW AND APPROVAL PRIOR TO INSTALLATION.
- B. ALL PLANTS SHALL BE DUG, PACKED, TRANSPORTED AND HANDLED WITH THE UTMOST CARE TO ENSURE ADEQUATE PROTECTION FROM INJURY DESICCATION.
- C. ALL PLANTS SHALL BE FREE FROM DISEASE AND INFESTATION, AND ALL LEGALLY REQUIRED AGRICULTURAL CERTIFICATIONS.
- D. ALL PLANTS SHALL BE PRUNED TO ENHANCE VIGOR PRIOR TO, OR UPON INSTALLATION,

TREE REMOVAL AND LANDSCAPE NOTES


- 1. THE CONTRACTOR MUST PROVIDE WRITTEN NOTICE TO THE MANCHESTER TOWNSHIP FORESTER A MINIMUM OF 48 HOURS PRIOR TO COMMENCEMENT OF TREE REMOVAL OPERATIONS.
- 2. THE CONTRACTOR MUST COMPLY WITH ALL PROVISIONS OF MANCHESTER TOWNSHIP ORDINANCE
- 3. THE EXISTING TREES MUST BE PROTECTED BY INSTALLATION OF A 4 FOOT ORANGE CONSTRUCTION FENCING. THE FENCING MUST BE PLACED AT THE LIMIT OF CLEARING PRIOR TO COMMENCEMENT OF TREE REMOVAL OPERATIONS
- 4. THE TREE PROTECTION FENCING SHALL BE INSTALLED AND APPROVED BY THE TOWNSHIP TREE SPECIALIST PRIOR TO ANY CLEARING OR EXCAVATION. TREE FENCING TO REMAIN UNTIL PROTECTION AUTHORIZED TO BE REMOVED BY THE TOWNSHIP TREE SPECIALIST OR AFTER THE FINAL CERTIFICATE OF OCCUPANCY IS ISSUED.
- 5. THE RETAINED TREES MUST BE IDENTIFIED BY FLAGGING EACH WITH RIBBON. THE CONTRACTOR MUST CONTACT THE MANCHESTER TOWNSHIP FORESTER TO SCHEDULE AN INSPECTION.
- 6. ALL REMAINING TREES ARE TO BE PRUNED AS NECESSARY IN ACCORDANCE WITH INDUSTRY STANDARDS BY A NJ CERTIFIED TREE EXPERT.
- 7. THE CONTRACTOR MUST COMPLY WITH ALL PROVISIONS OF MANCHESTER TOWNSHIP TREE REMOVAL ORDINANCE CHAPTER 403.
- 8. THE MANCHESTER TOWNSHIP FORESTER SHALL REQUIRE DEAD, BROKEN BRANCH AND SELECT RISK TREE REMOVAL ON REMAINING SPECIMEN TREES BEFORE PERFORMANCE BOND RELEASE.
- 9. THERE ARE NO SPECIMEN TREES LOCATED ON THIS SITE.
- 10. ALL TREE STUMPS AND OTHER TREE PARTS OR OTHER DEBRIS SHALL BE REMOVED FROM THE SITE AND DISPOSED OF IN ACCORDANCE WITH THE LAND. NO TREE STUMPS, PORTIONS OF A TREE TRUNK OR LIMBS SHALL BE BURIED ANYWHERE IN THE DEVELOPMENT.

- WHILE RETAINING NATURAL GROWTH HABIT OF THE PLANTS. THE CENTRAL LEADER SHALL NOT BE CUT; PLANTS PROVIDED IN THIS CONDITION SHALL NOT BE ACCEPTED. DAMAGED, BROKEN OR CONFLICTING BRANCHES SHALL BE PRUNED CLEANLY, FLUSH WITH THE MAIN
- E. ALL PLANTS SHALL BE NURSERY-GROWN AND TAGGED WITH A DURABLE LABEL INDICATING THE GENUS, SPECIES, SPECIFIED VARIETY OR CULTIVAR, PLANT PATENT NUMBER (IF A PATENTED TREE), AS WELL AS CULTURAL REQUIREMENTS, INCLUDING WATERING AND

4. MAINTENANCE

- A. ALL PLANTING SHALL BE WATERED AS NECESSARY FOR SOUND HORTICULTURAL PRACTICE DURING THE FIRST GROWING SEASON, TO ENSURE THEIR PROPER ESTABLISHMENT ALL TREES IN A SCREENING AREA SHALL BE WATERED WEEKLY THROUGH THE FIRST GROWING SEASON.
- B. IN GENERAL, SHRUBS ARE TO BE PLANTED AT INTERVALS WHICH WILL ALLOW THEM TO FULLY DEVELOP INTO CONTINUOUS MASSES OF THE INDIVIDUAL SPECIES. SHEARING OR SHAPING IS ONLY REQUIRED OR DESIRABLE WHERE DEAD OR CONFLICTING BRANCHING
- C. STAKING SHALL BE ATTACHED TO THE TREE WITH TWELVE GAUGE GALVANIZED WIRE COVERED WITH RUBBER OR PLASTIC HOSE, OR TREE TIES ESPECIALLY MANUFACTURED FOR THIS PURPOSE. THE LOOP IN CONTACT WITH THE TREE SHALL BE LOOSE ENOUGH TO PERMIT GROWTH AND PREVENT GIRDLING FOR TWO YEARS, BUT SHALL BE TIGHTLY BOUND TO THE STAKE TO PREVENT SLIPPING.
- D. EACH TREE SHALL BE WRAPPED WITH AN EXPANDABLE PAPER OR CLOTH TREATED TO LAST ONE YEAR. THIS WRAP SHALL EXTEND FROM THE GROUND LEVEL UP THE TRUNK TO THE FIRST BRANCHES. THIS WRAP SHOULD BE ATTACHED OR FASTENED AT EACH END WITH A MATERIAL THAT WILL PERMIT TREE GROWTH.
- E. A PERMANENT IRRIGATION SYSTEM SHALL BE INSTALLED TO ENSURE PROPER ESTABLISHMENT AND MAINTENANCE OF ALL PLANTINGS. THE APPLICANT SHOULD ADDRESS THE BOARD REGARDING THEIR PLANS TO INSTALL A PRIVATE WELL TO PROVIDE IRRIGATION
- F. A PRIVATE WELL SHALL BE PROVIDED TO SUPPLY IRRIGATION WATER TO THE SITE.


- D. NO TOPSOIL SHALL BE REMOVED FROM THE SITE OR USED AS SPOIL. TOPSOIL MOVED DURING THE COURSE OF CONSTRUCTION SHALL BE REDISTRIBUTED SO AS TO PROVIDE AT LEAST FOUR (4) INCHES OF SPREAD COVER TO ALL SEEDING AND PLANTING AREAS OF THE SITE AND SHALL BE STABILIZED BY SEEDING OR PLANTING. IN THE EVENT THAT THE QUANTITY OF TOPSOIL AT THE SITE IS INSUFFICIENT TO PROVIDE FOUR (4) INCHES OF COVER FOR ALL SEEDING AND PLANTING AREAS, THE DEVELOPER SHALL PROVIDE SUCH A COVER. TOPSOIL SHALL BE APPROVED BY THE TOWNSHIP ENGINEER.
- F TOPSOIL SHALL BE PROVIDED ON ALL LAWN AND PLANTING AREAS. TOPSOIL SHALL FITHER BE EXISTING MATERIAL THAT HAS BEEN STRIPPED AND STOCKPILED FOR REUSE OR NEWLY FURNISHED MATERIAL
- F. STREET AND PARKING LOT TREES SHALL HAVE NO BRANCHES LOWER THAN 7' ABOVE
- G. ALL DEAD OR SEVERELY DECLINING PLANTS SHALL BE REPLANTED WITHIN THE NEXT GROWING SEASON DURING PERFORMANCE AND MAINTENANCE BOND PERIODS.
- H. THE TREE PROTECTION FENCING SHALL BE INSTALLED AND APPROVED BY THE TOWNSHIP TREE SPECIALIST PRIOR TO ANY CLEARING OR EXCAVATION. TREE FENCING TO REMAIN UNTIL PROTECTION AUTHORIZED TO BE REMOVED BY THE TOWNSHIP TREE SPECIALIST OR AFTER THE FINAL CERTIFICATE OF OCCUPANCY IS ISSUED

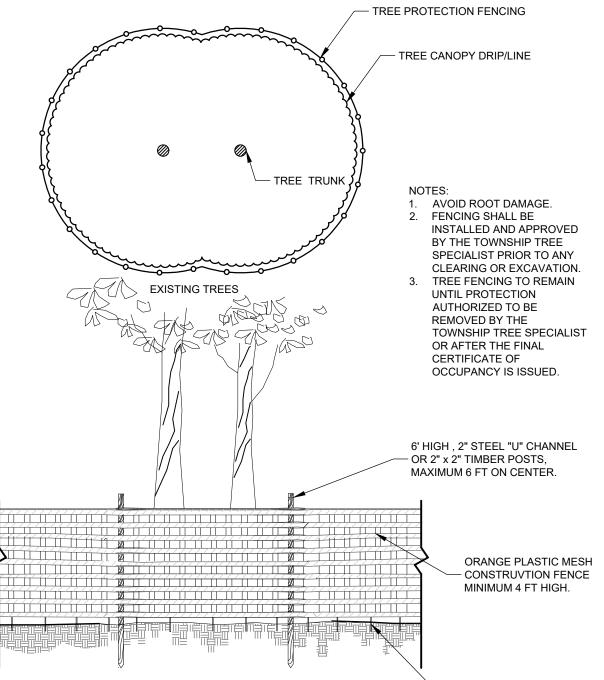

TREE PROTECTION FENCING NOT TO SCALE

USE 8" WIRE "U" TO SECURE FENCE BOTTOM 1/2 OF POST

HEIGHT BELOW GROUND.

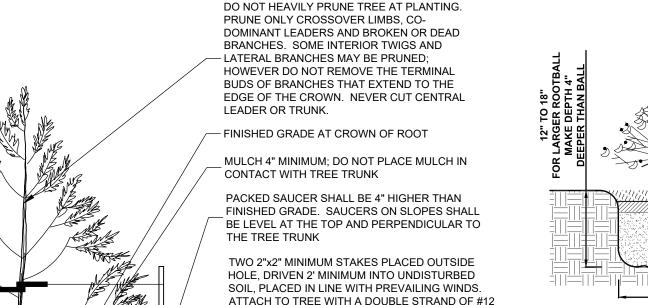

ESPECIALLY MANUFACTURED FOR THIS PURPOSE. SEE NOTE 1 CUT AND REMOVE BURLAP AND STRING FROM TOP ½ OF ROOT BALL: ALL WIRE BASKETS TO BE REMOVED PRIOR TO BACKFILLING OF THE PI ANTING PIT

- GAUGE GALVANIZED WIRE COVERED BY RUBBER

CONTACT WITH THE TREE, OR TREE TIES

OR PLASTIC HOSE WHERE THE WIRE COMES INTO

PLANTING MIXTURE INCORPORATING A MINIMUM 25% ORGANIC MATTER BY VOLUME PLANTING HOLE SHALL BE A MINIMUM

DEEPER THAN THE SOIL BALL OR ROOT


OF 12" LARGER IN DIAMETER AND 6"

COMPACTED SUBGRADE

NOTE:

1. THE LOOP IN CONTACT WITH THE TREE SHALL BE LOOSE ENOUGH TO PERMIT GROWTH AND PREVENT GIRDLING FOR TWO YEARS, BUT SHALL BE TIGHTLY BOUND TO THE STAKE TO PREVENT SLIPPING.

EVERGREEN TREE PLANTING

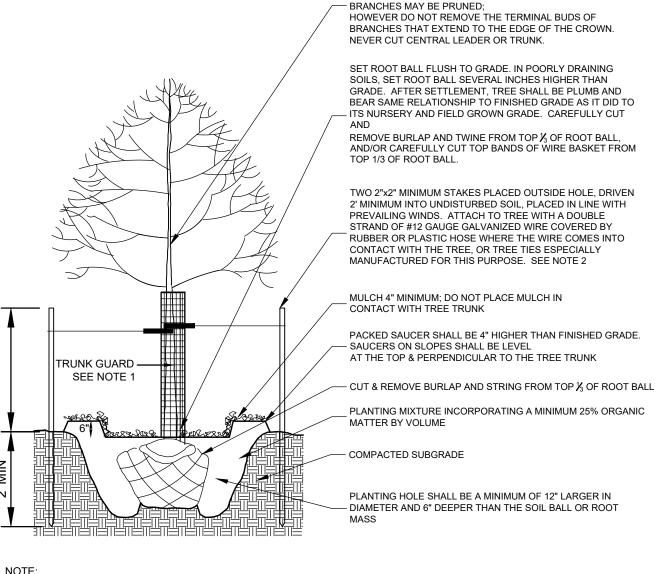


. EACH TREE SHALL USE A RIGID, PLASTIC OPEN MESH TRUNK GUARD TO PROTECT THE TREE FROM IRREPARABLE DAMAGE OF BUCK RUB. THE GUARD SHALL EXTEND FROM THE GROUND LEVEL UP THE TRUNK TO THE FIRST BRANCHES. THE GUARD SHALL BE ATTACHED OR FASTENED TO A STAKE TO PERMIT TREE GROWTH. 2. THE LOOP IN CONTACT WITH THE TREE SHALL BE LOOSE ENOUGH TO PERMIT GROWTH AND

PREVENT GIRDLING FOR TWO YEARS, BUT SHALL BE TIGHTLY BOUND TO THE STAKE TO

PREVENT SLIPPING.

TREE PLANTING

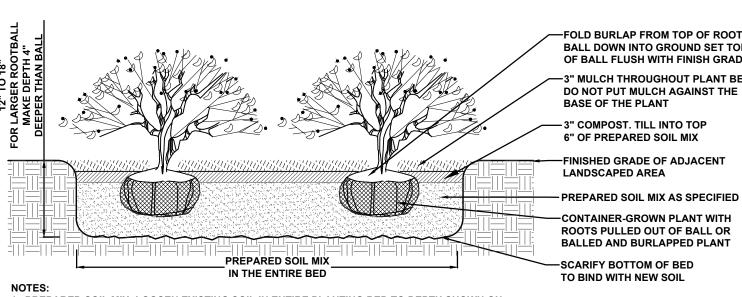

1. PREPARED SOIL MIX: LOOSEN EXISTING SOIL IN ENTIRE PLANTING BED TO DEPTH SHOWN ON DETAIL. AMEND EXISTING SOIL AS REQUIRED TO PRODUCE A SATISFACTORY TOPSOIL OR SUPPLY WITH IMPORTED TOPSOIL TO RAISE GRADES AND MIX AS SPECIFIED 2. ALL TREE BEDS SHALL PERCOLATE. NOTIFY ARCHITECT IF SUBSOIL CONDITIONS PREVENT WATER 3. SHRUB SHALL BEAR SAME RELATION TO FINISH GRADE AS IT DID TO ITS NURSERY FIELD GROWN

BALL DOWN INTO GROUND SET TOP OF BALL FLUSH WITH FINISH GRADE -3" MULCH THROUGHOUT PLANT BED DO NOT PUT MULCH AGAINST THE BASE OF THE PLANT -3" COMPOST. TILL INTO TOP 6" OF PREPARED SOIL MIX —FINISHED GRADE OF ADJACENT LANDSCAPED AREA


CONTAINER-GROWN PLANT WITH **ROOTS PULLED OUT OF BALL OR** BALLED AND BURLAPPED PLANT -SCARIFY BOTTOM OF BED

DO NOT HEAVILY PRUNE TREE AT PLANTING, PRUNE ONLY CROSSOVER LIMBS. CO-DOMINANT LEADERS AND BROKEN OR

DEAD BRANCHES. SOME INTERIOR TWIGS AND LATERAL

4. FOR CONTAINER-GROWN SHRUBS. USE FINGER OR SMALL HAND TOOL TO PULL THE ROOTS OUT OF THE OUTER LAYER OF SOIL; THEN CUT OR PULL APART ANY ROOTS THAT CIRCULATE THE PERIMETER

> SHRUB PLANTING DETAIL NOT TO SCALE

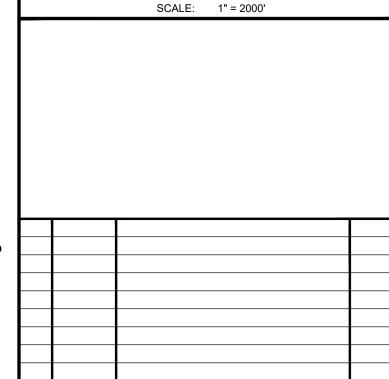

KEY MAP

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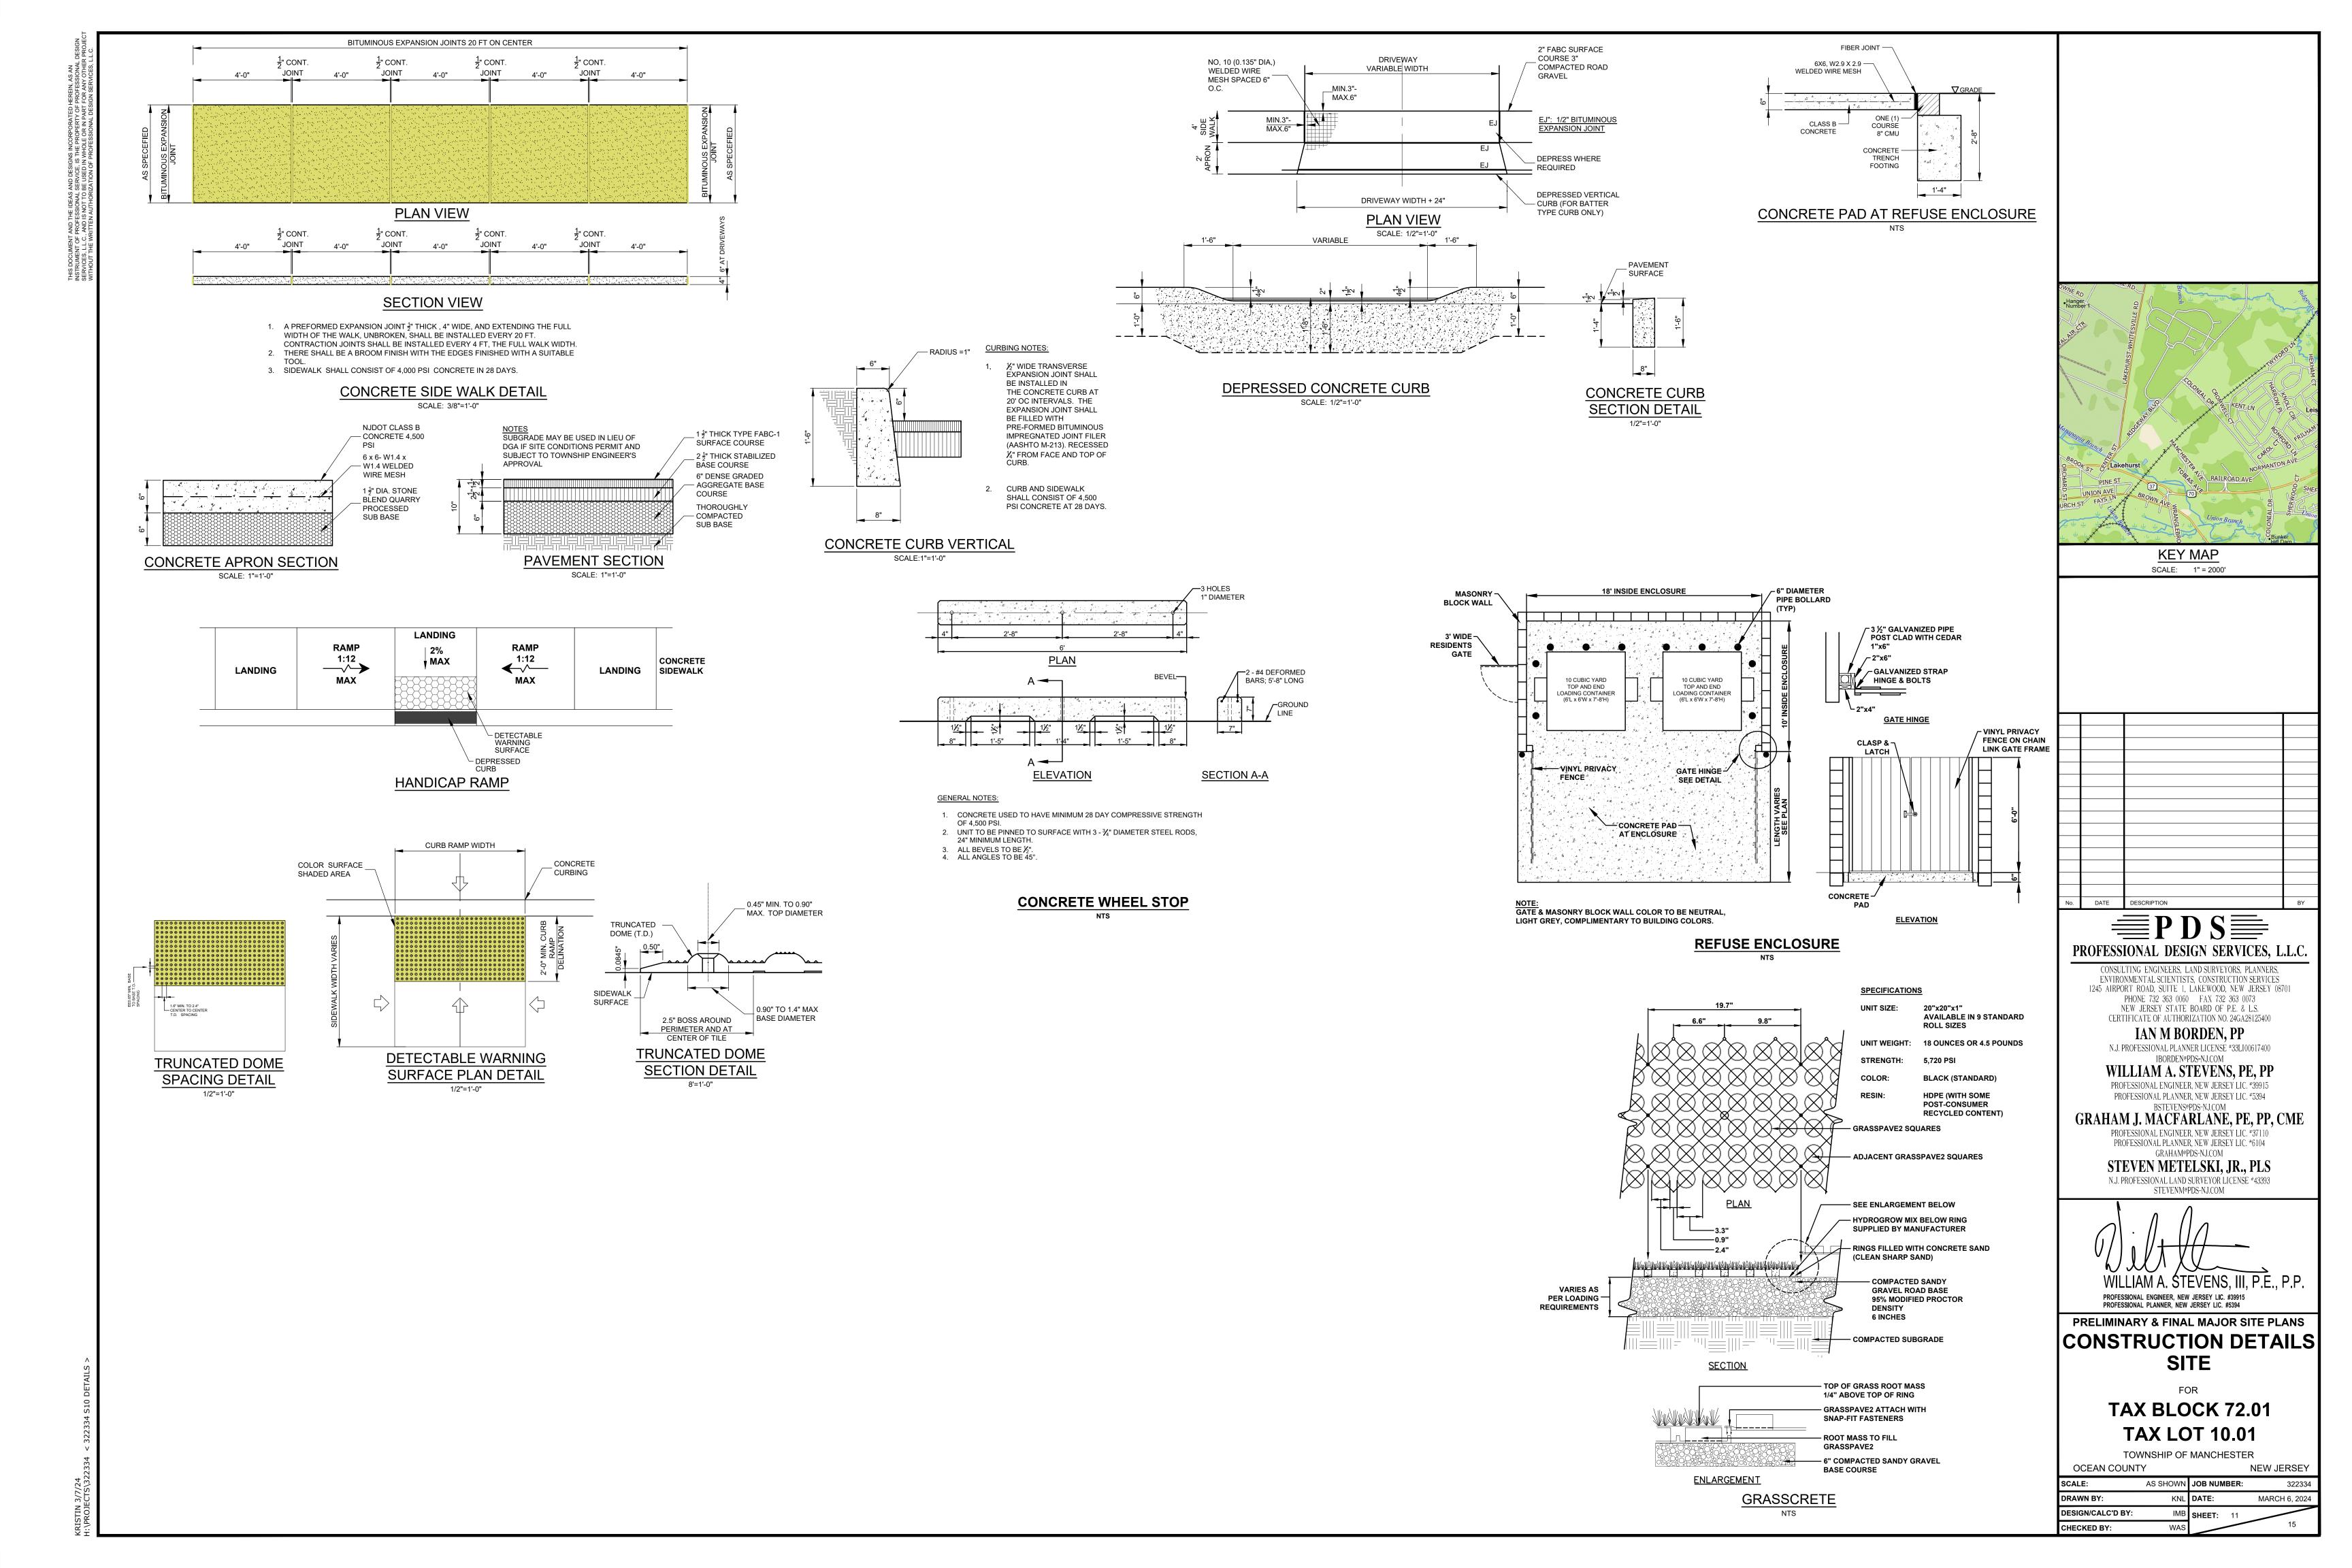
PRELIMINARY & FINAL MAJOR SITE PLANS


LANDSCAPE DETAILS

TAX BLOCK 72.01 TAX LOT 10.01

TOWNSHIP OF MANCHESTER

OCEAN COUNTY **NEW JERSEY** SCALE: AS SHOWN JOB NUMBER: DRAWN BY: KNL DATE: MARCH 6 2024 IMB SHEET: **DESIGN/CALC'D BY: CHECKED BY:**



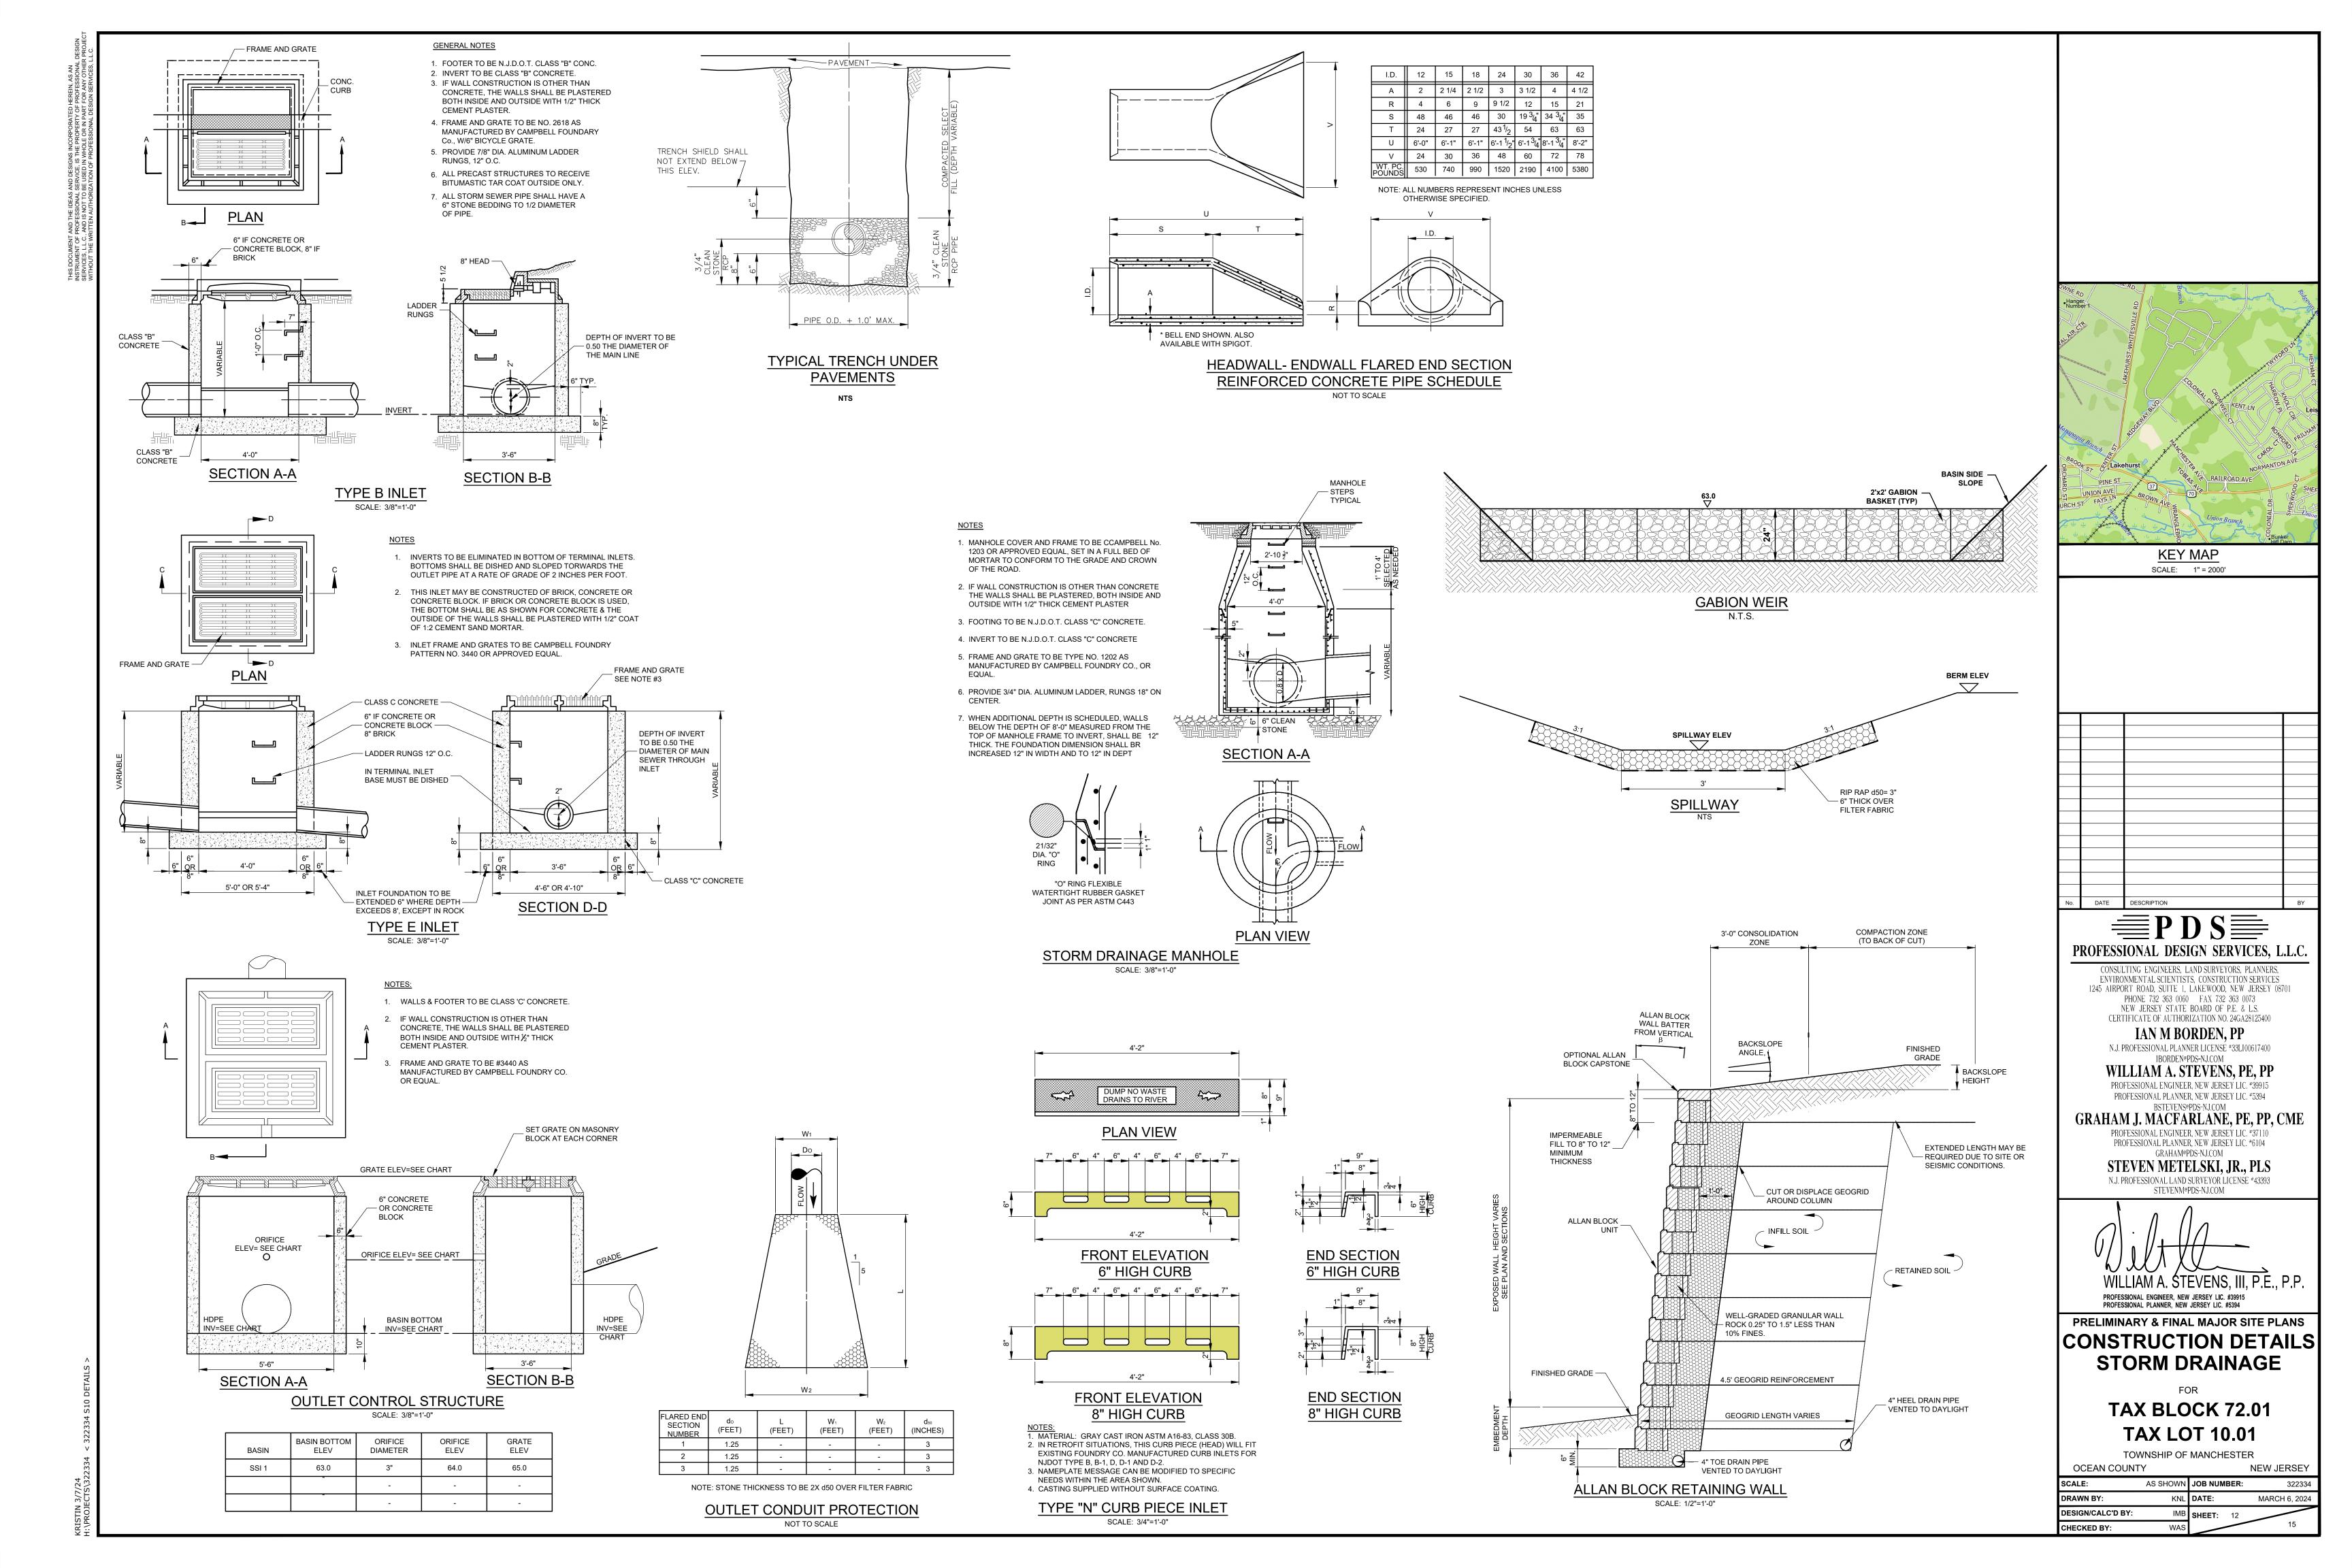


- 1. FRAME AND GRATE TO BE CAMPBELL FOUNDRY No. 2618 BICYCLE GRATE WITH TYPE "J" ECO CURB PIECE OR APPROVED EQUAL.
- 2. PROVIDE CAMPBELL FOUNDRY No. 2593-2254 DESIGN TO CONFORM TO HS-25 TRAFFIC LOADING.

CONSTRUCTION NOTES:

SANITARY PRECAST CONCRETE MANHOLE

SECTION A-A

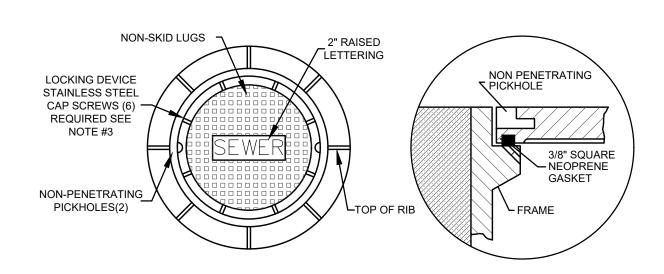


PLAN VIEW


"FLOW-SEAL" MANHOLE COVER

12" COARSE

AGGREGATE LAYER

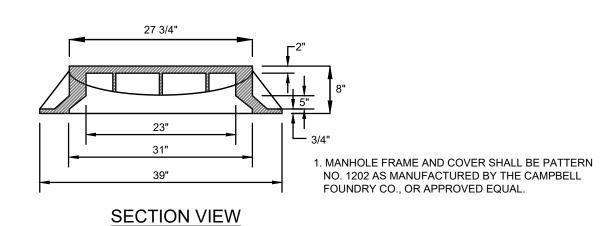


SANITARY MANHOLE FRAME & COVER N.T.S.

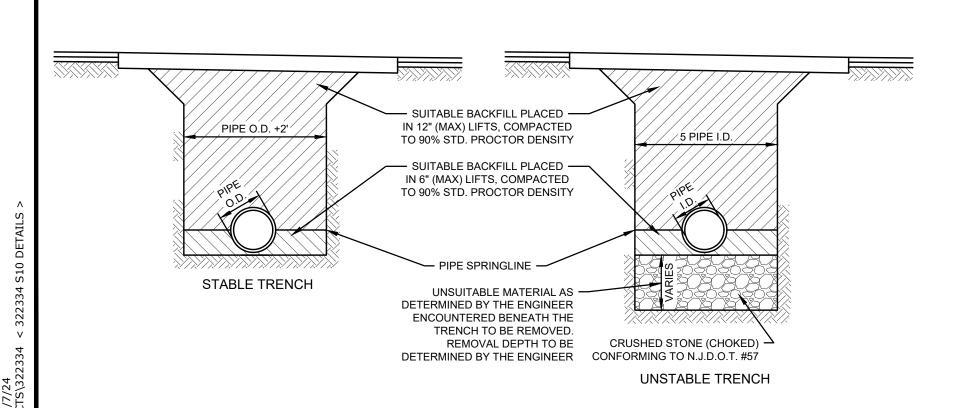

DUCTILE IRON PIPE BEDDING/BACKFILL DETAIL

N.T.S.

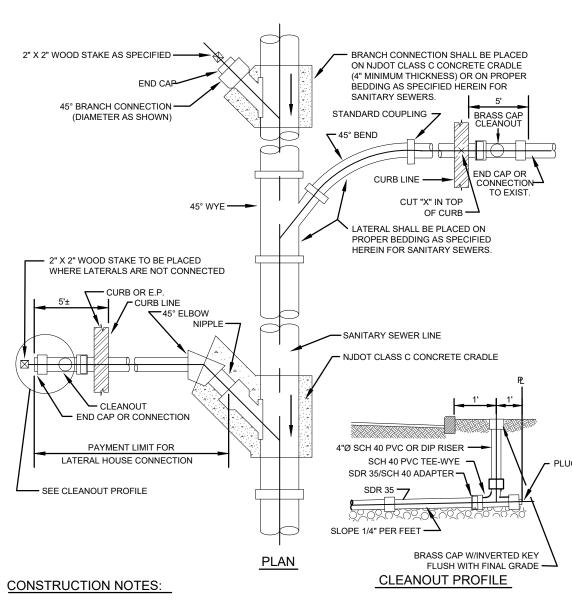


DETAIL SHOWS CONSTRUCTION OF A "BRANCH CONNECTION" AND OF TWO DIFFERENT TYPES OF "LATERAL HOUSE CONNECTION". TYPE OF CONNECTION IS AT CONTRACTOR'S OPTION.


 SIZE OF LATERAL TO BE AS SHOWN ON THE PLANS OR AS DIRECTED, 4" MINIMUM.


3. CLEAN-OUTS IN DRIVEWAYS SHALL BE COVERED WITH A MONUMENT BOX - CAMPBELL PATTERN NO. 4155 OR EQUAL.

BRANCH AND LATERAL HOUSE CONNECTIONS

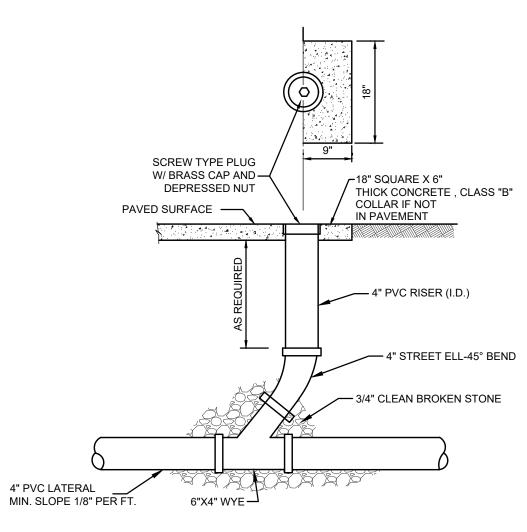

STANDARD CLEANOUT DETAIL

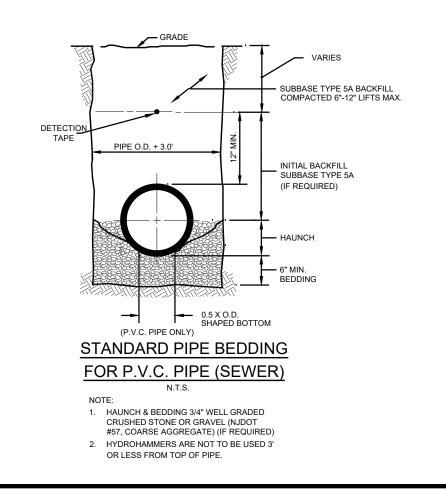

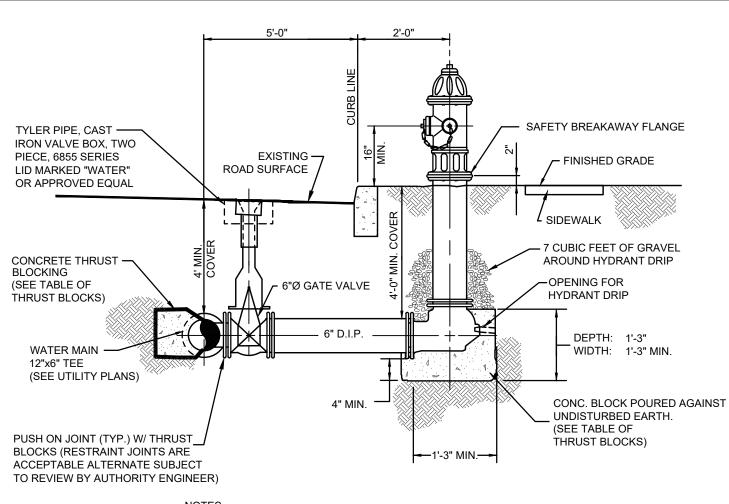


OTES:

1. HYDRANT TO BE MUELLER COMPANY SUPER CENTURION 250, MODEL A-423.

FIRE HYDRANT DETAIL

N.T.S.

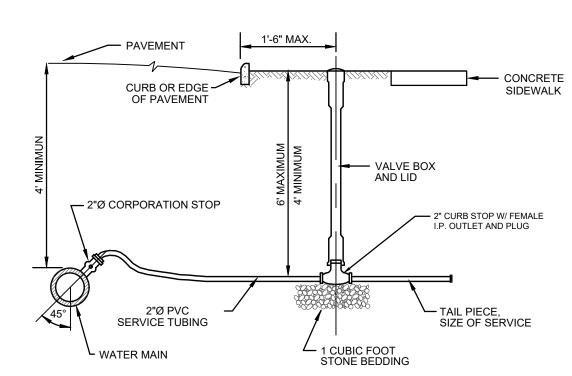


NOTES:

- YOKE ASSEMBLY INCLUDING INTEGRAL INLET VALVE, EXPANSION FITTING AND OUTLET VALVE TO BE INSTALLED WITHIN STRUCTURE BY APPLICANT.
- 2. METER AND REMOTE READOUT TO BE INSTALLED BY THE APPLICANT IN LOCATION APPROVED BY THE MANCHESTER TOWNSHIP DEPARTMENT OF UTILITIES.
- 3. CONTRACTOR SHALL CUT A "W" IN THE TOP OF THE CURB OVER THE WATER SERVICE.

 WATER SERVICE CONNECTION

NTS

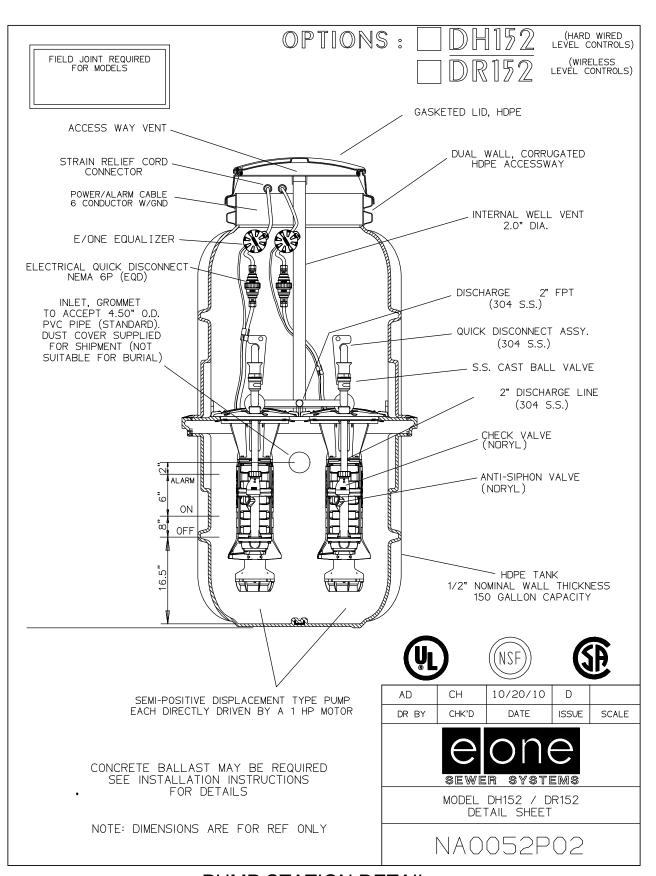

PUMP STATION DETAIL

SITE

WANTEN

SOLUTION

STORY

WANTON AVE

UNION AVE

UNION BRUNCH

SCALE: 1" = 2000'

No. DATE DESCRIPTION BY

PROFESSIONAL DESIGN SERVICES, L.L.C

CONSULTING ENGINEERS, LAND SURVEYORS, PLANNERS, ENVIRONMENTAL SCIENTISTS, CONSTRUCTION SERVICES 1245 AIRPORT ROAD, SUITE 1, LAKEWOOD, NEW JERSEY 08701 PHONE 732 363 0060 FAX 732 363 0073 NEW JERSEY STATE BOARD OF P.E. & L.S.

CERTIFICATE OF AUTHORIZATION NO. 24GA28125400

IAN M BORDEN, PP

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WILLIAM A STEVENS III PE E

WILLIAM A. STEVENS, III, P.E., PROFESSIONAL ENGINEER, NEW JERSEY LIC. #39915 PROFESSIONAL PLANNER, NEW JERSEY LIC. #5394

CONSTRUCTION DETAILS
SANITARY & WATER

TAX BLOCK 72.01 TAX LOT 10.01

TOWNSHIP OF MANCHESTER
OCEAN COUNTY N

OCEAN COUNTY

SCALE: AS SHOWN JOB NUMBER: 322334

DRAWN BY: KNL DATE: MARCH 6, 2024

DESIGN/CALC'D BY: IMB
CHECKED BY: WAS

MAINTENANCE PLAN CONSIDERATIONS

ACCESS:

ALL STORMWATER MANAGEMENT MEASURES COMPONENTS MUST BE READILY ACCESSIBLE FOR INSPECTION AND MAINTENANCE. THEREFORE, ACCESS MUST BE PROVIDED TO THE ENTIRE STORMWATER MEASURE VIA ROADWAYS AND PATHS. TREES, SHRUBS, AND UNDERBRUSH MUST BE PRUNED OR TRIMMED AS NECESSARY TO MAINTAIN THIS ACCESS. THIS INCLUDES PATHWAYS THROUGH THE VEGETATION ALONG PERMANENT POOL PERIMETERS, INCLUDING AQUATIC BENCHES, TO ALLOW FOR THE INSPECTION AND CONTROL OF MOSQUITO

INSPECTION AND MAINTENANCE EASEMENTS CONNECTED TO THE STREET OR RIGHT-OF-WAY SHOULD BE PROVIDED AROUND THE ENTIRE FACILITY. THE EXACT LIMITS OF THE EASEMENTS AND RIGHTS-OF-WAY SHOULD BE SPECIFIED ON THE PROJECT PLANS AND INCLUDED IN THE MAINTENANCE PLAN. ACCESS ROADS AND GATES SHOULD BE WIDE ENOUGH TO ALLOW PASSAGE OF NECESSARY MAINTENANCE VEHICLES AND EQUIPMENT, INCLUDING TRUCKS, BACKHOES, GRASS MOWERS, AND MOSQUITO CONTROL EQUIPMENT. IN GENERAL, A MINIMUM ACCESS ROADWAY WIDTH OF 12 FEET INSIDE A MINIMUM RIGHT-OF-WAY WIDTH OF 15 FEET IS RECOMMENDED. TO FACILITATE ENTRY, A CURB SHOULD BE PROVIDED WHERE AN ACCESS ROAD MEETS

A CURBED ROADWAY:

TO ALLOW SAFE MOVEMENT OF MAINTENANCE VEHICLES, ACCESS RAMPS SHOULD BE PROVIDED TO THE SHORELINE OR BOTTOM OF ALL FACILITIES WITH SIDE SLOPES GREATER THAN 3 FEET IN HEIGHT. ACCESS RAMPS SHOULD NOT EXCEED 10 PERCENT IN GRADE AND SHOULD BE SUITABLY STABILIZED TO PREVENT DAMAGE BY VEHICLES AND EQUIPMENT. TURNAROUNDS SHOULD BE PROVIDED WHERE BACKING UP IS DIFFICULT OR DANGEROUS. TO EXPEDITE OVERALL MAINTENANCE, VEHICLE AND EQUIPMENT STAGING AREAS SHOULD BE PROVIDED AT OR NEAR EACH FACILITY SITE.

TRAINING OF MAINTENANCE PERSONNEL:

DEPENDING ON THE SIZE, CHARACTER, COMPONENTS, AND LOCATION OF A STORMWATER MANAGEMENT MEASURE, MAINTENANCE PERSONNEL MAY REQUIRE SPECIALIZED TRAINING TO ENSURE THAT THE MEASURE IS MAINTAINED IN A MANNER CONSISTENT WITH ITS FUNCTION. SUCH TRAINING MAY ADDRESS SPECIALIZED INSPECTION OR MAINTENANCE TASKS AND/OR THE OPERATION OF SPECIALIZED MAINTENANCE EQUIPMENT.

COLLECTION AND DISPOSAL OF SEDIMENT, DEBRIS, AND TRASH FROM STORMWATER MANAGEMENT MEASURES MUST COMPLY WITH LOCAL, STATE, AND FEDERAL WASTE HANDLING AND DISPOSAL REGULATIONS. ALL COLLECTED MATERIAL MUST BE SENT TO APPROPRIATE DISPOSAL/RECYCLING FACILITIES.

THE SAFETY, NEEDS AND AESTHETIC PREFERENCES OF THE ADJACENT COMMUNITY CAN HELP DETERMINE THE TYPE, AMOUNT, AND FREQUENCY OF NECESSARY MAINTENANCE.

EMERGENCY MAINTENANCE:

EMERGENCY MAINTENANCE AND REPAIRS MUST BE PERFORMED IN A TIMELY MANNER.

DEVELOPMENT OF A STORMWATER MANAGEMENT MEASURE DESIGN AND THE INSPECTION AND MAINTENANCE TASKS NECESSARY TO KEEP IT FUNCTIONING RELIABLY MUST INCLUDE CONSIDERATIONS FOR THE SAFETY OF INSPECTION AND MAINTENANCE PERSONNEL WHO WILL BE WORKING IN OR NEAR THE MEASURE.

MAINTENANCE NOTES

REQUIRED MAINTENANCE PLAN PROCEDURES:

- 1. COPIES OF THE MAINTENANCE PLAN MUST BE PROVIDED TO THE OWNER AND OPERATOR OF THE STORMWATER MANAGEMENT MEASURE AND TO ALL REVIEWING AGENCIES. A COPY SHOULD ALSO BE PROVIDED TO THE LOCAL MOSQUITO CONTROL OR EXTERMINATION COMMISSION UPON REQUEST.
- THE TITLE AND DATE OF THE MAINTENANCE PLAN AND THE NAME AND/OR TITLE AND ADDRESS OF THE PERSON WITH OVERALL MAINTENANCE RESPONSIBILITY MUST BE RECORDED ON THE DEED OF THE PROPERTY ON WHICH THE STORMWATER MANAGEMENT MEASURE IS LOCATED. ANY CHANGE IN THE NAME OR TITLE MUST ALSO BE RECORDED ON THE DEED, PARTICULARLY IF THERE IS A CHANGE OF PROPERTY
- 3. THE MAINTENANCE PLAN MUST BE EVALUATED FOR EFFECTIVENESS AT LEAST ANNUALLY AND MUST BE REVISED AS NEEDED.
- 4. A DETAILED, WRITTEN LOG OF ALL PREVENTATIVE AND CORRECTIVE MAINTENANCE PERFORMED AT THE STORMWATER MANAGEMENT MEASURE MUST BE KEPT. INCLUDING A RECORD OF ALL INSPECTIONS AND COPIES OF MAINTENANCE WORK ORDERS.
- THE PERSON WITH OVERALL MAINTENANCE RESPONSIBILITY MUST MAKE THE MAINTENANCE PLAN, LOGS AND OTHER RECORDS AVAILABLE FOR REVIEW UPON REQUEST FROM A PUBLIC ENTITY WITH JURISDICTION OVER ACTIVITIES AT THE SITE.

REQUIRED MAINTENANCE PLAN COMMENTS

1. ENTITY RESPONSIBLE FOR OVERALL MAINTENANCE OF THE STORMWATER MANAGEMENT MEASURE:

2. SCHEDULE OF MAINTENANCE INSPECTIONS AND MAINTENANCE TASKS:

EXTENDED DETENTION BASIN:

- A. GENERAL MAINTENANCE ALL EXTENDED DETENTION BASIN COMPONENTS EXPECTED TO RECEIVE AND/OR TRAP DEBRIS AND SEDIMENT MUST BE3 INSPECTED FOR CLOGGING AND EXCESSIVE DEBRIS AND SEDIMENT ACCUMULATION AT LEAST FOUR TIMES ANNUALLY AS WELL AS AFTER EVERY STORM EXCEEDING 1 INCH OF RAINFALL. SUCH COMPONENTS MAY INCLUDE BOTTOMS, TRASH RACKS, LOW FLOW CHANNELS, OUTLET STRUCTURES, RIPRAP OR GABION APRONS, AND INLETS. SEDIMENT REMOVAL SHOULD TAKE PLACE WHEN THE BASIN IS THOROUGHLY DRY. DISPOSAL OF DEBRIS AND TRASH SHOULD BE DONE AT SUITABLE DISPOSAL/RECYCLING SITES AND IN COMPLIANCE WITH ALL APPLICABLE LOCAL, STATE AND FEDERAL WASTE REGULATIONS.
- VEGETATED AREAS: MOWING AND/OR TRIMMING OF VEGETATION MUST BE PERFORMED ON A REGULAR SCHEDULE BASED ON SPECIFIC SITE CONDITIONS. GRASS SHOULD BE MOWED AT LEAST ONCE A MONTH DURING THE GROWING SEASON. VEGETATE AREAS MUST ALSO BE INSPECTED AT LEAST ANNUALLY FOR EROSION AND SCOUR. VEGETATED AREAS SHOULD ALSO BE INSPECTED AT LEAST ANNUALLY FOR UNWANTED GROWTH, WHICH SHOULD BE REMOVED WITH MINIMUM DISRUPTION TO THE BOTTOM SURFACE AND REMAINING VEGETATION, WHEN ESTABLISHING OR RESTORING VEGETATION, BIWEEKLY INSPECTIONS OF VEGETATION HEALTH SHOULD BE PERFORMED DURING THE FIRST GROWING SEASON OR UNTIL THE VEGETATION IS ESTABLISHED. ONCE ESTABLISHED, INSPECTIONS OF VEGETATION HEALTH, DENSITY AND DIVERSITY SHOULD BE PERFORMED AT LEAST TWICE ANNUALLY DURING BOTH THE GROWING AND NON-GROWING SEASONS. THE VEGETATIVE COVER SHOULD BE MAINTAINED AT 85%. IF VEGETATION HAS GREATER THE 50% DAMAGE, THE AREA SHOULD BE REESTABLISHED IN ACCORDANCE WITH THE ORIGINAL SPECIFICATIONS AND THE INSPECTION REQUIREMENTS PRESENTED ABOVE. ALL USE OF FERTILIZERS, MECHANICAL TREATMENTS, PESTICIDES AND OTHER MEANS TO ASSURE OPTIMUM VEGETATION HEALTH SHALL NOT COMPROMISE THE INTENDED PURPOSE OF THE EXTENDED DETENTION BASIN. ALL VEGETATION DEFICIENCIES SHOULD BE ADDRESSED WITHOUT THE USE OF FERTILIZERS AND PESTICIDES WHENEVER POSSIBLE.
- C. STRUCTURAL COMPONENTS: ALL STRUCTURAL COMPONENTS MUST BE INSPECTED FOR CRACKING, SUBSIDENCE, SPALLING, EROSION, AND DETERIORATION AT LEAST ANNUALLY.
- OTHER MAINTENANCE CRITERIA:

THE OPERATION AND MAINTENANCE PLAN MUST INDICATE THE APPROXIMATE TIME THAT THE SYSTEM WOULD NORMALLY TAKE TO COMPLETELY DRAIN THE STORMWATER QUALITY DESIGN STORM RUNOFF VOLUME, THIS NORMAL DRAIN TIME SHOULD THEN BE USED TO EVALUATE THE SYSTEM'S ACTUAL PERFORMANCE. IF SIGNIFICANT INCREASES OR DECREASES IN THE DRAIN TIME ARE OBSERVED. THE SYSTEM'S OUTLET STRUCTURE, UNDERDRAIN SYSTEM, AND BOTH GROUNDWATER AND TAILWATER LEVELS MUST BE EVALUATED AND APPROPRIATE MEASURES TAKEN TO COMPLY WITH THE MAXIMUM DRAIN TIME REQUIREMENTS AND MAINTAIN THE PROPER FUNCTIONING OF THE BASIN.

INFILTRATION BASIN: A. GENERAL MAINTENANCE:

ALL INFILTRATION BASIN COMPONENTS EXPECTED TO RECEIVE AND/OR TRAP DEBRIS AND SEDIMENT MUST BE INSPECTED FOR CLOGGING AND EXCESSIVE DEBRIS AND SEDIMENT ACCUMULATION AT LEAST FOUR TIMES ANNUALLY AS WELL AS AFTER EVERY STORM EXCEEDING 1 INCH OF RAINFALL. SUCH COMPONENTS MAY INCLUDE BOTTOMS, RIPRAP OR GABION APRONS, AND INFLOW POINTS. THIS APPLIES TO BOTH SURFACE AND SUBSURFACE INFILTRATION BASINS. SEDIMENT REMOVAL SHOULD TAKE PLACE WHEN THE BASIN IS THOROUGHLY DRY. DISPOSAL OF DEBRIS & TRASH SHOULD BE DONE AT SUITABLE DISPOSAL/RECYCLING SITES AND IN COMPLIANCE WITH ALL APPLICABLE LOCAL, STATE AND FEDERAL WASTE REGULATIONS. STUDIES HAVE SHOWN THAT READILY VISIBLE STORMWATER MANAGEMENT FACILITIES LIKE INFILTRATION BASINS RECEIVE MORE FREQUENT AND THOROUGH MAINTENANCE THAN THOSE IN LESS VISIBLE, MORE REMOTE LOCATIONS. READILY VISIBLE FACILITIES CAN ALSO BE INSPECTED FASTER AND MORE EASILY BY MAINTENANCE AND MOSQUITO CONTROL PERSONNEL.

B. VEGETATED AREAS:

MOWING AND/OR TRIMMING OF VEGETATION MUST BE PERFORMED ON A REGULAR SCHEDULE BASED ON SPECIFIC SITE CONDITIONS. GRASS SHOULD BE MOWED AT LEAST ONCE A MONTH DURING THE GROWING SEASON. VEGETATED AREAS MUST ALSO BE INSPECTED AT LEAST ANNUALLY FOR EROSION AND SCOUR. THE STRUCTURE MUST BE INSPECTED FOR UNWANTED TREE GROWTH AT LEAST ONCE A YEAR, WHEN ESTABLISHING OR RESTORING VEGETATION, BIWEEKLY INSPECTIONS OF VEGETATION HEALTH SHOULD BE PERFORMED DURING THE FIRST GROWING SEASON OR UNTIL THE VEGETATION IS ESTABLISHED. ONCE ESTABLISHED, INSPECTIONS OF VEGETATION HEALTH, DENSITY AND DIVERSITY SHOULD SHOULD BE PERFORMED AT LEAST TWICE ANNUALLY DURING BOTH THE GROWING AND NON-GROWING SEASON. IF VEGETATION HAS GREATER THAN 50% DAMAGE, THE AREA SHOULD BE REESTABLISHED IN ACCORDANCE WITH THE ORIGINAL SPECIFICATIONS AND THE INSPECTION REQUIREMENTS PRESENTED ABOVE. ALL USE OF FERTILIZERS, MECHANICAL TREATMENTS, PESTICIDES AND OTHER MEANS TO ASSURE OPTIMUM VEGETATION HEALTH MUST NOT COMPROMISE THE INTENDED PURPOSE OF THE BIORETENTION SYSTEM. ALL VEGETATION DEFICIENCIES SHOULD BE ADDRESSED WITHOUT THE USE OF FERTILIZERS AND PESTICIDES WHENEVER POSSIBLE. ALL VEGETATED AREAS SHOULD BE INSPECTED AT LEAST ANNUALLY FOR UNWANTED GROWTH. WHICH SHOULD BE REMOVED WITH MINIMUM DISRUPTION TO THE REMAINING VEGETATION AND BASIN

C. STRUCTURAL COMPONENTS: ALL STRUCTURAL COMPONENTS MUST BE INSPECTED FOR CRACKING, SUBSIDENCE,

SPALLING, EROSION AND DETERIORATION AT LEAST ANNUALLY.

- D. OTHER MAINTENANCE CRITERIA: THE OPERATION AND MAINTENANCE PLAN MUST INDICATE THE APPROXIMATE TIME THAT THE BASIN WOULD NORMALLY TAKE TO DRAIN THE STORMWATER QUALITY DESIGN STORM RUNOFF VOLUME BELOW THE GROUND SURFACE. THIS NORMAL DRAIN OR DRAWDOWN TIME SHOULD THEN BE USED TO EVALUATE THE BASIN'S ACTUAL PERFORMANCE. IF SIGNIFICANT INCREASES OR DECREASES IN THE DRAIN TIME ARE OBSERVED, THE BASIN'S BOTTOM SURFACE, SUBSOIL AND BOTH GROUNDWATER AND TAILWATER LEVELS MUST BE EVALUATED AND APPROPRIATE MEASURES TAKEN TO COMPLY WITH THE MAXIMUM DRAIN TIME REQUIREMENTS AND MAINTAIN THE PROPER FUNCTIONING OF THE BASIN. THIS APPLIES TO BOTH SURFACE INFILTRATION BASINS. THE BOTTOM SAND LAYER IN A SURFACE INFILTRATION BASIN SHOULD BE INSPECTED AT LEAST MONTHLY AS WELL AS AFTER EVERY STORM EXCEEDING ONE INCH OF RAINFALL. THE PERMEABILITY RATE OF THE SOIL BELOW THE BASIN MAY ALSO BE RETESTED PERIODICALLY. IF THE WATER FAILS TO 72 HOURS AFTER THE END OF THE STORM, CORRECTIVE MEASURES MUST BE TAKEN. ANNUAL TILLING
- PROBLEMS FOUND DURING MAINTENANCE INSPECTIONS SHALL BE CORRECTED. THESE INCLUDE THE RESTORATION OF ERODED AREAS, REPAIR OR REPLACEMENT OF STORMWATER MANAGEMENT MEASURE COMPONENTS, RESTORATION OF VEGETATION, AND REPAIR OR REPLACEMENT OF NON-VEGETATED LININGS.

NY LIGHT EQUIPMENT CAN ASSIST IN MAINTAINING INFILTRATION CAPACITY AND BREAK UP

- 4. THE EQUIPMENT NECESSARY TO PERFORM THE MAINTENANCE TASKS ARE AS FOLLOWS:
- B. LAWN MOWING EQUIPMENT G. WHEEL BARROWS GAS POWERED TRIMMERS GAS POWERED HEDGE TRIMMERS GAS POWERED BLOWERS CHAIN SAW FERTILIZER/PESTICIDE APPLICATION RAKES SHOVELS WASTE RECEPTACLES

CLOGGED SURFACES.

PICKS L. MAINTENANCE VEHICLES 5. COST ESTIMATE OF THE INSPECTION AND MAINTENANCE TASKS:

1.	INSPECT BASIN, REMOVE & DISPOSE OF SILT AND DEBRIS	UNITS 1	FREQUENCY 1	UNIT PRICE \$250	ANNUAL COST \$250
2.	INSPECT BOTTOM SAND LAYER AFTER EVERY STORM EVENT EXCEEDING ONE INCH OF RAINFALL	1	3	\$150	\$450
3.	INSPECT OUTLET STRUCTURE, INLET $\&$ OUTLET PIPING AND MAKE REPAIRS	1	1	\$200	\$200
4.	INSPECT AND MAINTAIN FENCE & BASIN ACCESS DRIVE	1	2	\$150	\$300
5.	DEEP TILL AND RE-GRADE SAND BOTTOM	1	0.20	\$1000	\$200
TOTAL ESTIMATED ANNUAL COST					

70 TOP OF BERM ELEV=65.8 EXISTING EMERGENCY GRADE SPILLWAY ELEV=64.8 BASIN BOTTOM ELEV=61.0 └ 6" SAND LAYER


BASIN CROSS SECTION

1+00

0+00



SCALE: 1" = 2000'

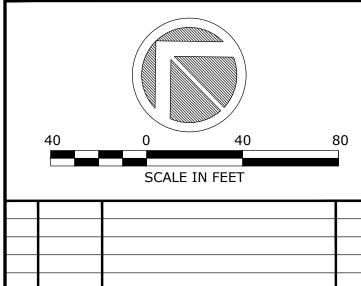



CONSULTING ENGINEERS. LAND SURVEYORS. PLANNERS. ENVIRONMENTAL SCIENTISTS, CONSTRUCTION SERVICES 1245 AIRPORT ROAD, SUITE 1, LAKEWOOD, NEW JERSEY 08701 PHONE 732 363 0060 FAX 732 363 0073 NEW JERSEY STATE BOARD OF P.E. & L.S. CERTIFICATE OF AUTHORIZATION NO. 24GA28125400

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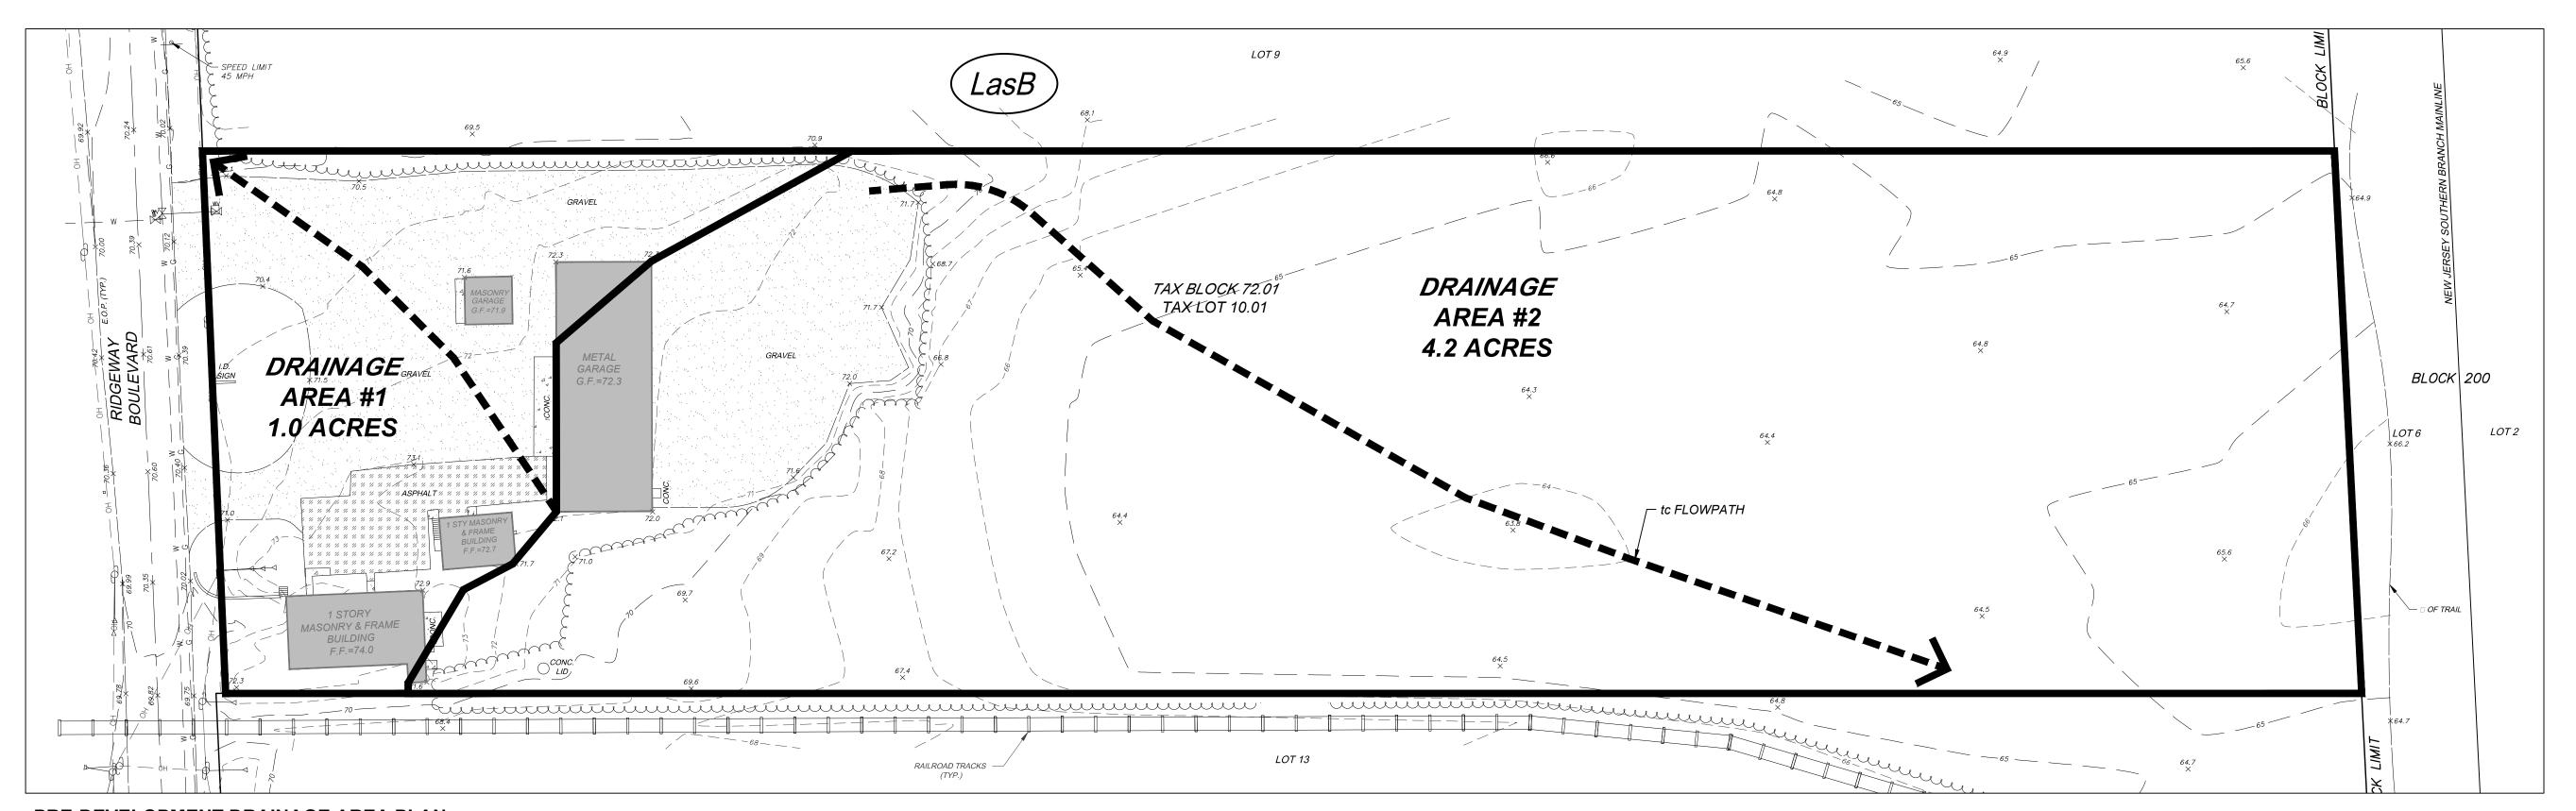
PROFESSIONAL PLANNER, NEW JERSEY LIC. #5394 PRELIMINARY & FINAL MAJOR SITE PLANS

STORMWATER MAINTENANCE PLAN


TAX BLOCK 72.01 TAX LOT 10.01

TOWNSHIP OF MANCHESTER

OCEAN COUNTY			NEW JERSEY
SCALE:	1" = 40'	JOB NUMBER:	322334
DRAWN BY:	KNL	DATE:	MARCH 6, 2024
DESIGN/CALC'D BY:	IMB	SHEET: 14	
CHECKED BY:	WAS		15



PRE-DEVELOPMENT DRAINAGE AREA PLAN SCALE: 1" = 40'

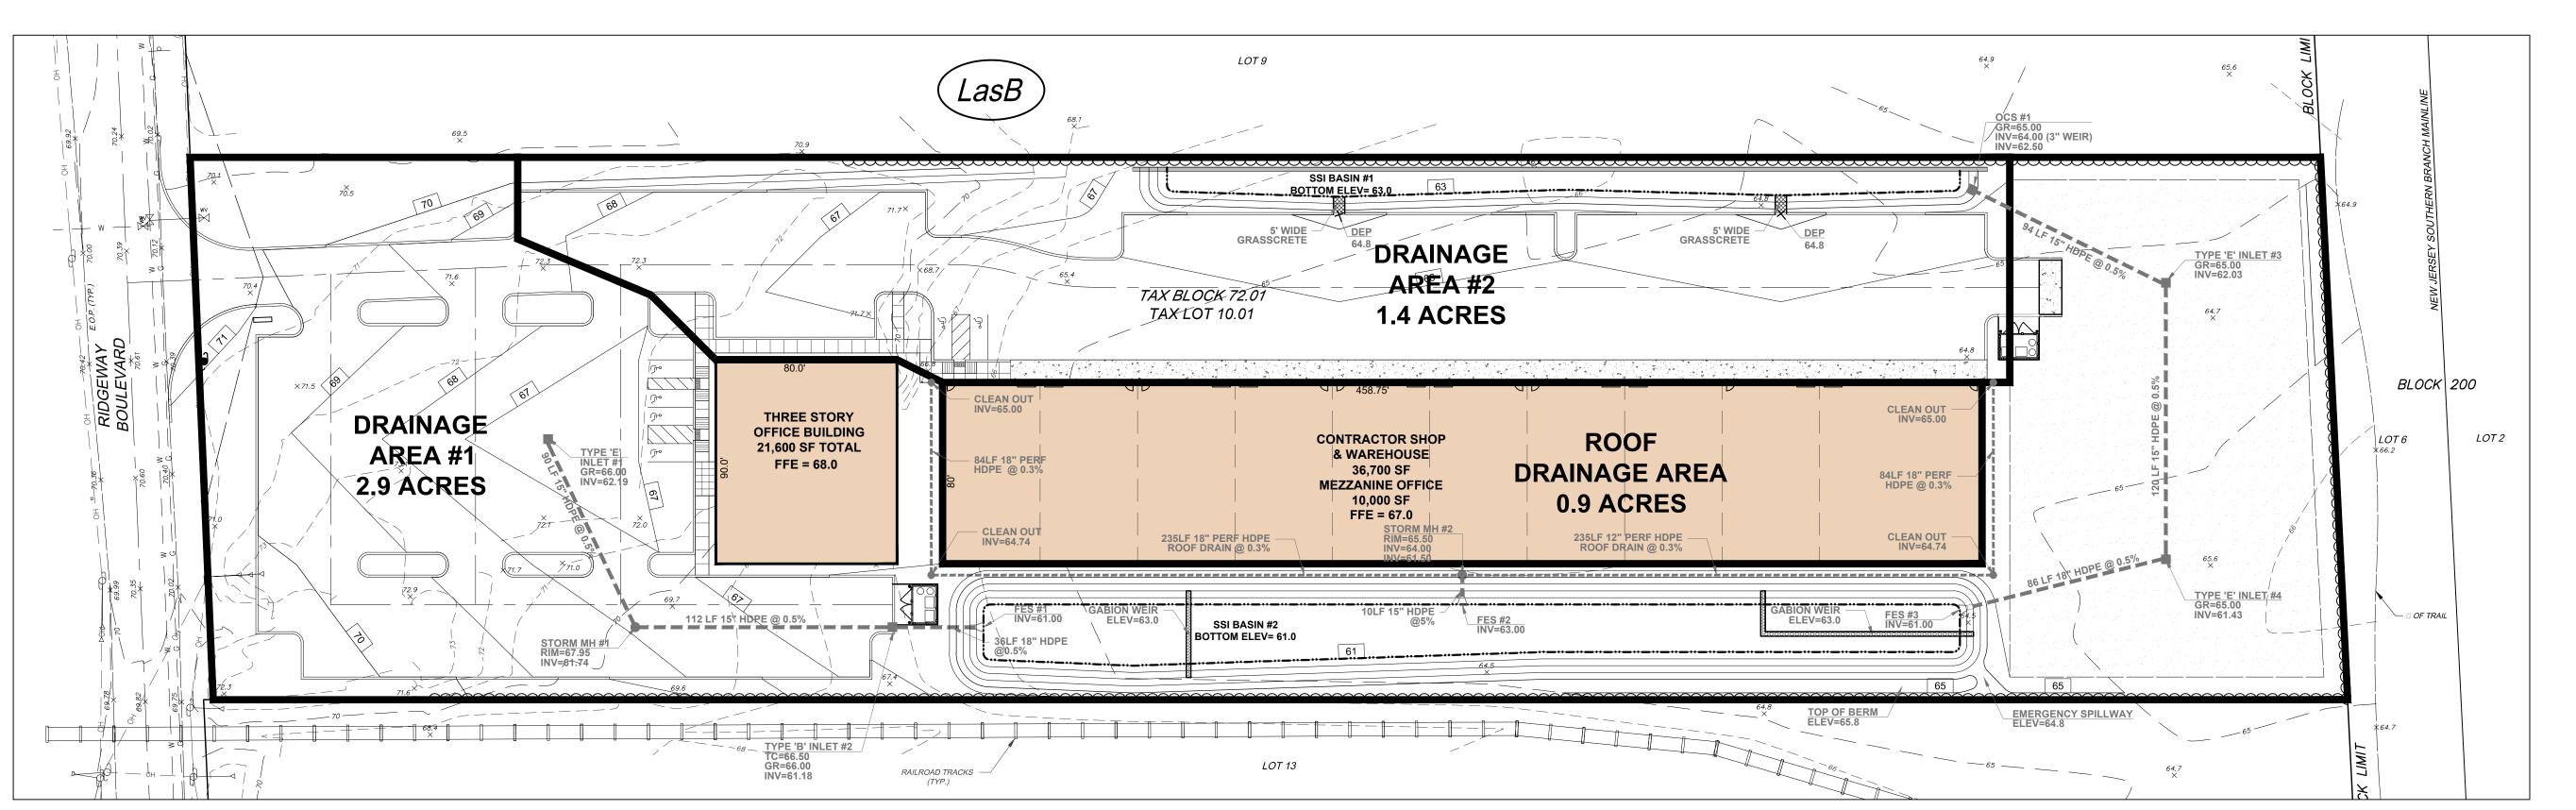

POST DEVELOPMENT DRAINAGE AREA PLAN

SOIL TYPE NOTE ON SITE SOILS ARE: LasB - LAKEWOOD SAND (HSG A) AS PER UNITED STATES DEPARTMENT OF AGRICULTURE

NATURAL RESOURCE CONSERVATION SERVICE WEB SOIL


DRAINAGE AREA LIMIT LINE

<u>LEGEND</u>

SOIL LIMIT LINE

FLOW

SOIL TYPE

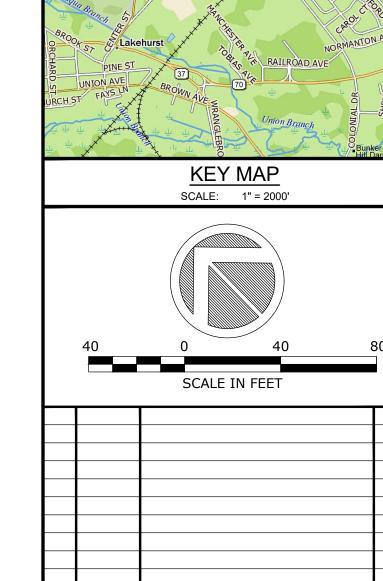

PROFESSIONAL DESIGN SERVICES, L.L.O

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NEW JERSEY STATE BOARD OF P.E. & L.S. CERTIFICATE OF AUTHORIZATION NO. 24GA28125400 IAN M BORDEN, PP

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PROFESSIONAL ENGINEER, NEW JERSEY LIC. #39915 PROFESSIONAL PLANNER, NEW JERSEY LIC. #5394 PRELIMINARY & FINAL MAJOR SITE PLANS

DRAINAGE AREA PLAN

TAX BLOCK 72.01 TAX LOT 10.01

TOWNSHIP OF MANCHESTER OCEAN COUNTY

NEW JERSEY 1" = 40' **JOB NUMBER**: SCALE: DRAWN BY: KNL DATE: MARCH 6, 2024 DESIGN/CALC'D BY: IMB SHEET: CHECKED BY: